


85 Pinckney St Boston, MA

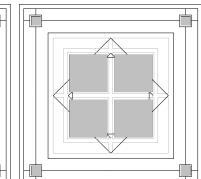

ZONING DIMENSIONAL REGULATIONS

Any Dwelling/Other (E) Any Dwelling/Other (N) Any Dwelling/Other **ZONING DISTRICT H-2-65**

TYPE OF USE	Residential	Residential	No change
LOT SIZE	None/None	1,740 SF	No change
LOT AREA (Min for add dwelling)	None/None	7,501 SF (E) Floor Area	No change
LOT WIDTH (Min)	None/None	24.0'	No change
GROSS FLOOR AREA		7,143 SF	7,388SF
FAR (Max)	2.0/2.0	NC, 4.11	NC, 4.25
HEIGHT OF BUILDING (Stories)	None/None	6	No change
HEIGHT OF BUILDING (Feet)	65.0'/65.0'	NC, 67.8'	No change
USABLE OPEN SPACE (Min per dwelling)	150/None	416 SF	No change
FRONT YARD	20.0'/20.0'	NC, 0.0'	No change
SIDE YARD	0.0'/0.0'	0.0'	No change
REAR YARD	10.0'+L/20	NC (Ivaded by bay)	No change


NC*** = Existing Non-Conforming Condition

* Group R limited to 75ft and 5 stories

**NA = Non- Applicable

780 CMR BUILDING CODE (IBC2015) & MA AMENDMENTS

CODE REFERENCE	CODE DESCRIPTION	EXISTING CONDITION	PROPOSED CONDITION
521 CMR 9.2.1, 9.4.	Renovation and Reuse exempt from Group I Dwelling Units and Group II Dwelling Units	Contains less than 20 units	1 unit, no change
521 CMR 10.1	Public and Common Areas for existing buildings with less than 12 units not required to be accessible	Contains less than 12 units	{ 1 unit, no change }
780 CMR 34 2.02	Type of Addition, Alteration, or Repair		Interior alteration
780 CMR 34 301.2	Prescriptive Compliance Method		Prescriptive Compliand Method
780 CMR 310.1	Use Group	R-3	R-3, no change
780 CMR Table 503	Height Limitations Stories *	6 stories	6 stories, no change
780 C 3	Height Limitations	67.8'	67.8', no change
	Area Limitations	1361 sf (R-2 24,000 sf)	1361 sf, no change
780 CMR 504.2	Sprinkler Height Increase +20ft		
	Sprinkler Height Increase + 1 Story		
780 CMR Table 601	Building Type	III B	III B, No change
	Primary structural frame	0	1
	Bearing Walls EXT	2	2
	Bearing Walls INT	0	0
	Non-Bearing walls and partitions INT	0	0
	Floor Construction	0	1
	Roof Construction	0	0
780 CMR Table 602	Fire Separation X<5c	1	1
	Fire Separation 5 <x<10< td=""><td>1</td><td>1</td></x<10<>	1	1
	Fire Separation 10 <x<30< td=""><td>1</td><td>1</td></x<30<>	1	1
	Fire Separation $X \le 30$	0	0
780 CMR 903.3.1.1	NFPA 13 Sprinkler System	NA**	13
780 CMR 903.3.3.2	Quick Response or Residential automatic sprinklers required.	NA**	Yes

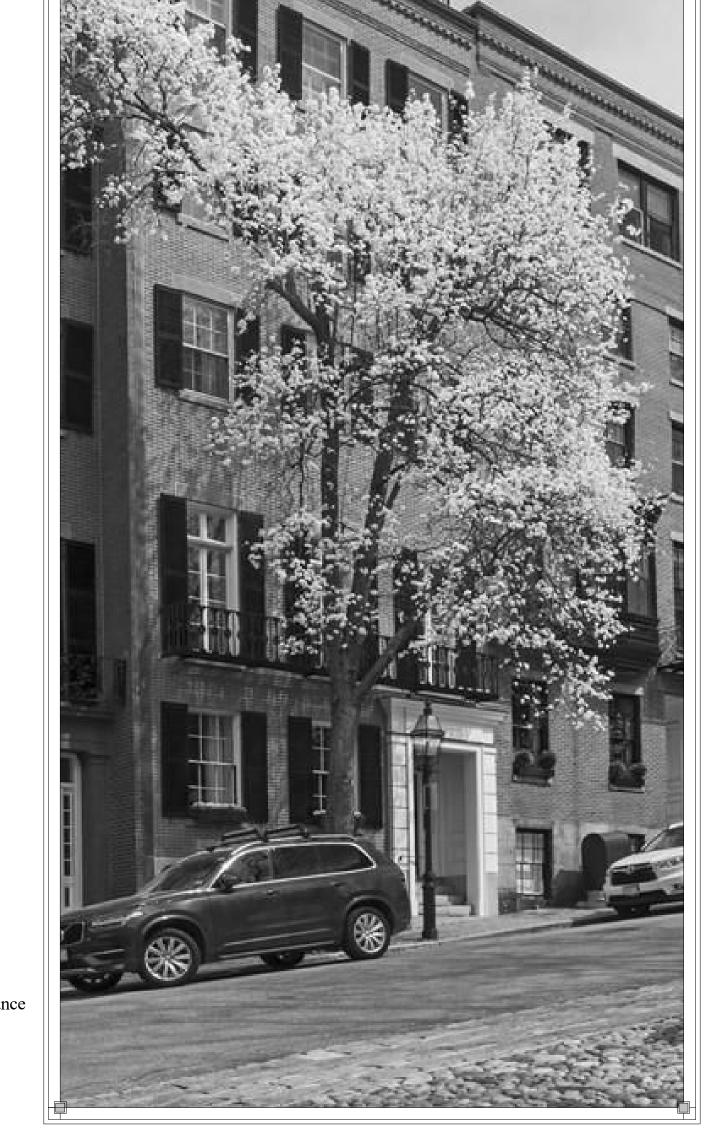

MEYER & MEYER, INC.

ARCHITECTURE O INTERIORS 396 COMMONWEALTH AVENUE BOSTON, MASSACHUSETTS 02215



Amended Permit Set February 7, 2019

Project Team

OWNER Sir Peter Wood

Rick Burns, Owners Representative 85 Pinckney Street Boston, MA, 02114 Phone: 561-820-1400 Email: rick@davisgeneralcontracting.com

ARCHITECT
Meyer & Meyer Architects, Inc.
Attn: Adam Gilmore 396 Commonwealth Avenue Boston, MA 02215 Phone: 617-266-0555 Email: agilmore@meyerandmeyerarchitects.com

INTERIOR DESIGNER

Marc - Michaels Attn: Rachel Ortiz 720 West Morse Boulevard Winter Park, FL 32789 Phone: 407-629-0441 x3137 Email: rachelo@marc-michaels.com

STRUCTURAL ENGINEER Webb Structural Services Attn: Dan Webb 670 Main Street Reading, MA 01867 Phone: 781-779-1330 Email: dan@webbss.net


MECHANICAL ENGINEER Sun Engineering Attn: Sean Fennessy 491 Maple Street Suite 209 Danvers, MA 01923 Phone: 978-777-7765 Email: sean@sunengineering.net Corneliusen Consulting Inc Attn: Joel Corneliusen Phone: 781-248-7497


Email: joel@fpeconsulting.com




LOCATION MAP

Boston, Massachusetts

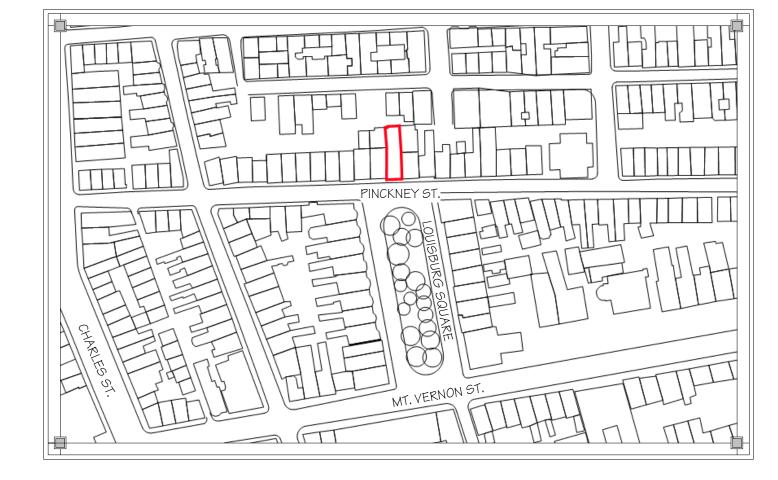


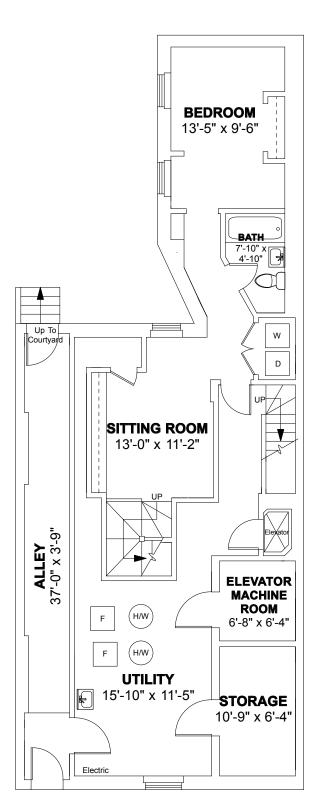


GARDEN LEVEL PLAN
Ceiling Height = 7'-0"

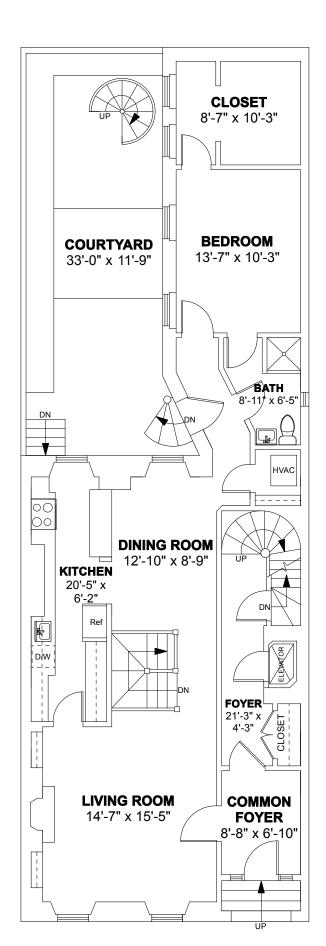


FIRST FLOOR PLAN
Ceiling Height = 9'-5"

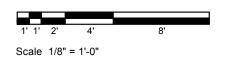


EXISTING CONDITIONS FLOOR PLANS				
JOB NO.	DATE: MARCH 2018		SCALE: 1/8" = 1'-0"	
NATIONAL FLOOR PLANS 398 COLUMBUS AVENUE SUITE 100 BOSTON MA 02116 800.328.0217 TEL		85 F	PINCKNEY STREET BOSTON, MA	l

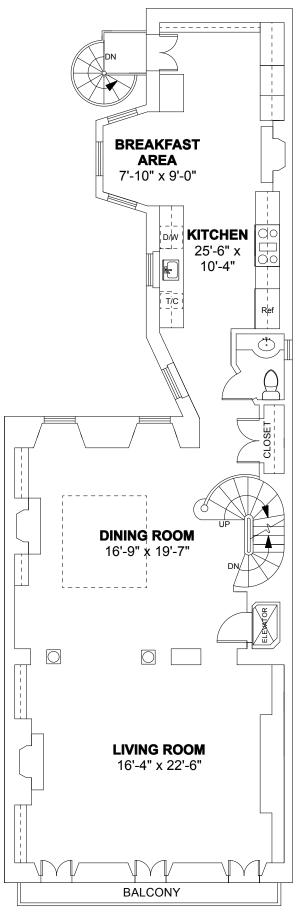

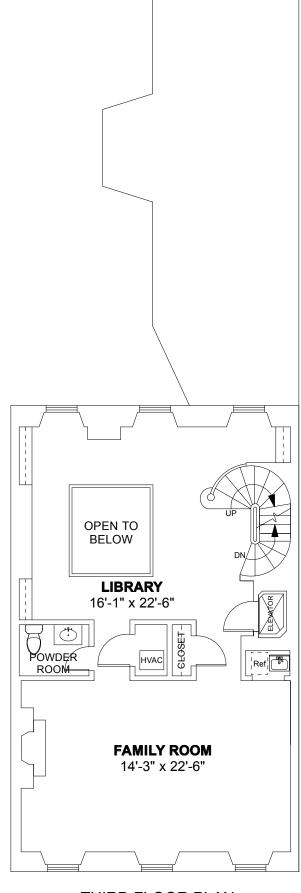


SECOND FLOOR PLAN
Ceiling Height = 10'-9"




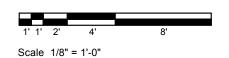


EXISTING CONDITIONS FLOOR PLANS				
JOB NO.	DATE: MARCH 2018		SCALE: 1/8" = 1'-0"	\neg
NATIONAL FLOOR PLANS 398 COLUMBUS AVENUE SUITE 100 BOSTON MA 02116 800.328.0217 TEL		85 F	PINCKNEY STREET BOSTON, MA	

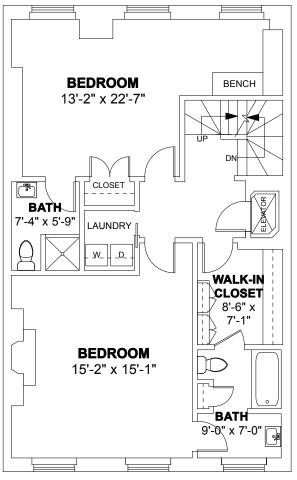


FOURTH FLOOR PLAN
Ceiling Height = 7'-10"

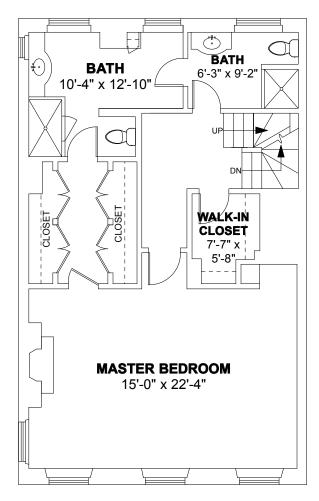

FIFTH FLOOR PLAN
Ceiling Height = 8'-10"

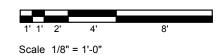

EXISTING CONDITIONS FLOOR PLANS				
JOB NO.	DATE: MARCH 2018		SCALE: 1/8" = 1'-0"	\neg
NATIONAL FLOOR PI 398 COLUMBUS AVENUE SUITE 100 B 800.328.0217 TEL		85 F	PINCKNEY STREET BOSTON, MA	一 3

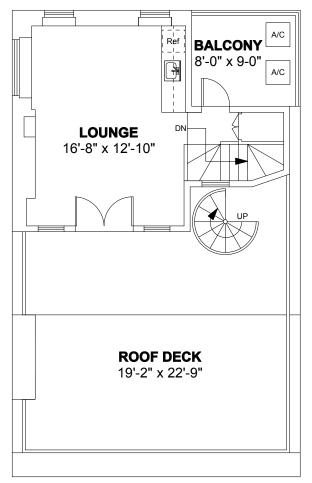

ROOF DECK
18'-6" x 13'-11"


ROOF PLAN

SIXTH FLOOR PLAN
Ceiling Height = 8'-0"



Scale 1/8" = 1'-0"

EXI	STING CONDIT	TIONS FLOOR	PLANS	
JOB NO.	DATE: MARCH 2018		SCALE: 1/8" = 1'-0"	
NATIONAL FLOOR PLANS 398 COLUMBUS AVENUE SUITE 100 BOSTON MA 02116 800.328.0217 TEL		85 F	PINCKNEY STREET BOSTON, MA	74

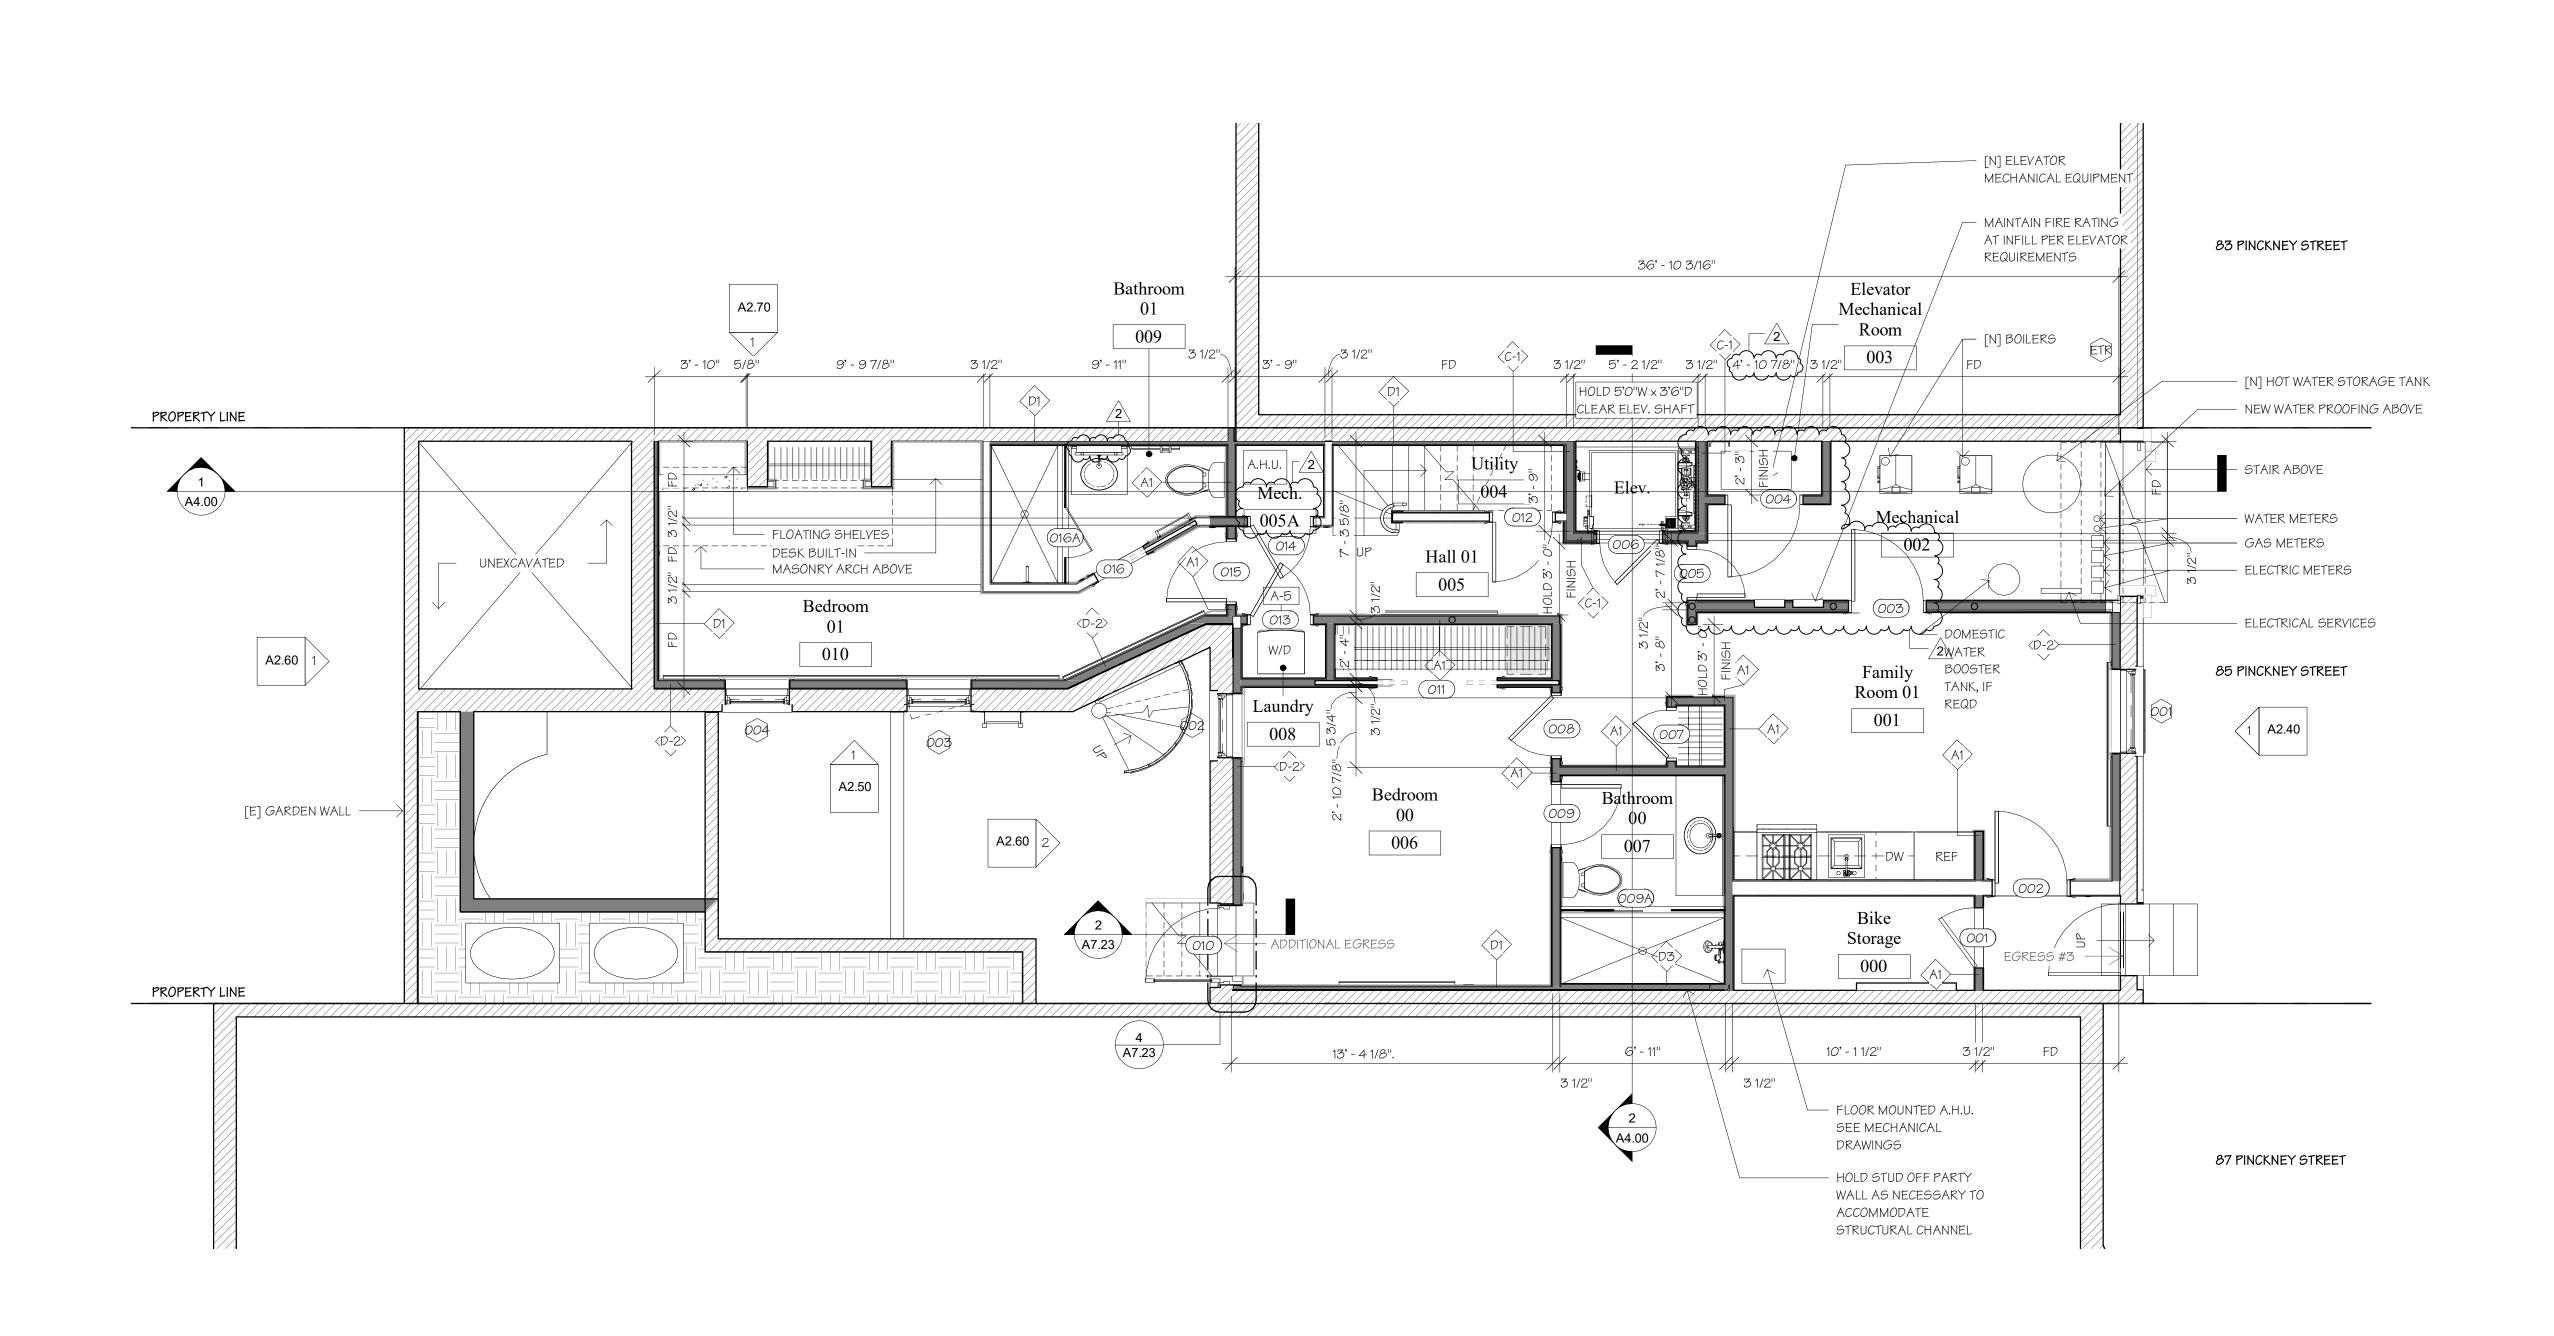

Basement Floor Plan 1/4" = 1'-0"

GENERAL CONSTRUCTION NOTES

1. TYPICAL WALL ASSEMBLIES:

A. UNLESS OTHERWISE NOTED, ALL NEW AND/OR PATCHED INTERIOR WALL CONSTRUCTION SHALL BE 2" X 4" (UNLESS OTHERWISE NOTED, SEE PLAN) WOOD STUDS @ 16" O.C. WITH 1/2" GWB AND 1/8" SKIM COAT PLASTER FINISH ON BOTH SIDES OF STUDS, TYP. REFER TO FINISH SCHEDULE FOR TRIM & WALL FINISHES

2. G.C. SHALL BE RESPONSIBLE FOR PROVIDING WOOD BLOCKING AS REQUIRED FOR ALL ITEMS INCLUDING BUT NOT LIMITED TO CLOSET POLES, BUILT-INS, CABINETS SHELVING, BATHROOM ACCESSORIES AND DECORATIVE LIGHTING.

3. ALL NEW WALL CONSTRUCTION AND/OR WALL, CEILING, AND FLOOR INFILL THAT TIES INTO EXISTING CONSTRUCTION SHALL BE FURRED OUT AS REQUIRED TO ALIGN WITH EXISTING ADJACENT OR ABUTTING. ALL SEAMS AND JOINTS SHALL BE FULLY CONCEALED, TYPICAL THROUGHOUT. 4. PATCHED WOOD FLOORING SHALL BE TOOTHED INTO EXISTING ADJACENT FLOORING, TYPICAL. THROUGHOUT U.N.O

ALL GWB AT NON SHOWER WET WALLS SHALL BE MOISTURE RESISTANT WITH 1/8" SKIM COAT PLASTER FINISH, ALL SHOWER WALLS TO HAVE

CEMENTATIOUS BACKER BOARD

SEE TYPICAL WALL TYPE SHEET AND PLANS FOR WALL INSULATION INFORMATION.

ALL FLOORS TO HAVE 6" MINIMUM MINERAL WOOL BATT ACOUSTIC INSULATION

INTERIOR PAINTING SHALL INCLUDE ALL PREP WORK, ONE COAT PRIMER, AND TWO COATS FINISH. WALLS AND CEILINGS SHALL BE LATEX, U.N.O. AT ALL STONE/TILE WORK, G.C. SHALL FULLY COORDINATE ALL JOINT AND SEAM LOCATIONS WITH ARCHITECT PRIOR TO CONSTRUCTION. ALL TILE TO BE PROVIDED AND INSTALLED BY G.C. PER OWNER'S SELECTIONS.

10. AT ALL CLOSETS AND COAT CLOSETS, DASHED LINE INDICATES SHELF WITH ROD UNLESS OTHERWISE DETAILED.

11. G.C. IS RESPONSIBLE FOR REPAIRS FOR ANY DAMAGE TO NEW OR EXISTING ITEMS DUE TO CONSTRUCTION WORK, TYPICAL. FULLY PROTECT EXISTING WOOD FLOOR FINISH TO REMAIN DURING CONSTRUCTION. CONTRACTOR IS FULLY RESPONSIBLE FOR REPAIRING ANY DAMAGES, NICKS,

REFER TO ALL DRAWINGS, SCHEDULES, ALLOWANCES, DETAILS, AND ALL NOTES FOR SCOPE OF WORK. ANY ALLOWANCES PROVIDED ARE FOR MATERIALS ONLY, UNLESS OTHERWISE NOTED. ALL LABOR SHALL BE CARRIED IN BASE BID, TYPICAL.

ALL CLOSETS SHALL BE 2'-O" DEEP UNLESS OTHERWISE NOTED. PROVIDE ROD AND SHELF AT ALL NEW CLOSETS.

UNLESS OTHERWISE NOTED, DOOR JAMBS SHALL BE LOCATED 5" FROM ADJACENT WALL AND DOOR JAMB (FRAME TO FRAME)

REPAIR AND REPAINT EXISTING INTERIOR SHUTTERS

ALL FURRED EXTERIOR (AND PARTY) WALL CAVITIES TO BE FILLED WITH OPEN CELL INSULATION; SEE WALL TYPES.

18. PROVIDE ALL NEW WINDOW HARDWARE; SEE HARDWARE SCHEDULE

TYPICAL PLAN NOTES ELECTRICAL

RELOCATE THREE METERS TO NEW MECH ROOM, MAINTAIN ONE METER FOR MAIN HOUSE, ONE METER FOR BASEMENT UNIT AND ONE METER FOR BUILDING

<u>AV</u>-PER AV CONSULTANT

5. MOTORIZED SHADES

1. LIGHTING CONTROL SYSTEM

2. FULL BUILDING WIFI COVERAGE

4. TELEVISION DISTRIBUTION SYSTEM

3. BASIC TELEPHONE SYSTEM WITH ENTRY DOOR INTERCOM CONNECTIVITY

ALL NEW ELECTRICAL SERVICE AT BUILDING INTERIOR

ALL NEW ELECTRICAL SUB PANELS ALL NEW ELECTRICAL WIRING

ALL NEW ELECTRICAL DEVICES

ALL NEW ADDITIONAL ELECTRICAL DEVICES REQUIRED BY CODE

SMOKE/CO DETECTORS HARD WIRED WITH BATTERY BACKUP

PROVIDE JAMB SWITCHES AT ALL CLOSET DOORS, UNLESS OTHERWISE NOTED ELECTRIC RADIANT HEAT IN HIS AND HERS BATHROOMS

RELOCATE WATER METER (AND BOOSTER UNIT) TO NEW MECH ROOM, PROVIDE FOR FUTURE SP SIDE SUB METER TO BASEMENT UNIT

ALL NEW HOT AND COLD WATER SUPPLIES ALL NEW DRAIN LINES AND DRAIN STACKS AT BUILDING INTERIOR

ALL NEW DOMESTIC WATER HEATING EQUIPMENT

ALL NEW AREA HEATING WATER HEATING EQUIPMENT

ALL NEW PLUMBING FIXTURES ALL NEW ADDITIONAL PLUMBING DEVICES REQUIRED BY CODE

ALL NEW GAS LINES AT BUILDING INTERIOR NEW WATER SOFTENER, SUMP PUMP AND PRESSURE BOOSTER PUMP

ALL NEW HEATING AND COOLING EQUIPMENT AT INTERIOR OF BUILDING ALL NEW DUCT, INSULATE PER CODE ALL NEW CONDENSER/HEAT PUMP AT EXTERIOR OF BUILDING

ALL NEW HEATING AND COOLING EQUIPMENT PLUMBING CONNECTIONS ALL NEW HEATING AND COOLING ELECTRICAL CONNECTIONS NEW ELEVATOR VENTILATION

NEW GAS LOG INSERTS WHERE NOTED, INSTALL NEW CONCENTRIC CHIMNEY LINERS THESE LOCATIONS SUPPLY GRILLES TO BE TITUS 301FL, RETURN GRILLES TO BE TITUS 350FL

FIRE PROTECTION ALL NEW SPRINKLER NFPA 13 SYSTEM ALL NEW FIRE ALARM SYSTEM

NEW DEDICATED 1 1/2" (OR 2") WATER SUPPLY LINE FROM STREET MAIN TO BUILDING

NEW ROPED HYDRAULIC ELEVATOR AND ASSOCIATED EQUIPMENT IN ENLARGED EXISTING SHAFT

Room

name

101

PLAN LEGEND

NEW DOOR

NEW WALL

EXISTING WALL TO REMAIN

WALL TO BE DEMOLISHED

EXISTING MASONRY


WALL TO REMAIN

ROOM TAG

R.D.

- DETAIL#

EXTERIOR ELEVATION TAG

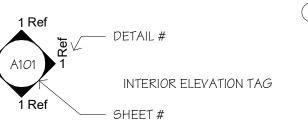

UNLESS NOTED OTHERWISE CENTERLINE ABOVE FINISHED FLOOR GENERAL CONTRACTOR VERIFY IN FIELD FIELD DIMENSION

ROOF DRAIN

WALL TYPE; REFER TO A4.10

FLOOR TYPE; REFER TO A4.11

WINDOW TAG; REFER TO WINDOW

DOOR TAG; REFER TO DOOR SCHEDULE ENLARGED PLAN KEY DIMENSION TO FACE OF STUD

85 Pinckney Street Boston, MA

85 Pinckney St

Project:

MEYER & MEYER

ARCHITECTURE AND INTERIORS

F: 617.266.29: T: 617.266.05

Issue Dates and Revisions:

10/23/2018 11/01/2018 Bid Set 12/12/2018 50% CD Set 100% CD Set 01/11/2019 02/14/2019 ASI-001 2 ASI-002 TBD

General Notes: General Contractor shall make all Subcontractors and Suppliers aware of the requirements of these notes. All work shall be performed in compliance with all applicable Local, State and National Building, Life Safety and Electrical Codes.

General Contractor shall be responsible for securing all permits as necessary for the completion of work shown throughout the Contract Documents. General Contractor shall lay out in the field the entire

constructing any part, and shall verify all existing conditions and locations before proceeding. Failure to verify dimensions and conditions before proceeding may subject the General Contractor to the required removal of completed work at General Contractor cost, if a discrepancy which could have been discovered causes modifications to the plans.

General Contractor shall coordinate the dimensiona requirements between the work of the various trades. Any discrepancies found in the plans, dimensions, existing conditions or any apparent error in the classifying or specifying of a product, material or means of assembly is to be pointed out to the Architect immediately.

Drawings shall not be scaled for dimensions and/or sizes Owner and Architect assume no responsibility for use of incorrect scale. Regardless of whether or not an item is shown or specified, General Contractor shall provide said item if it is necessary for the proper installation or function of an item shown or specified. Suppliers and Subcontractors

shall inform the General Contractor of their requirements for the work of other trades, which may not be indicated,

All dimensions to interior/exterior walls indicated are to face of stud wall or concete/c.m.u. unless noted otherwise.

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Author

Checker


Drawing Title:

Basement Floor

Drawn:

Checked:

Project Number:

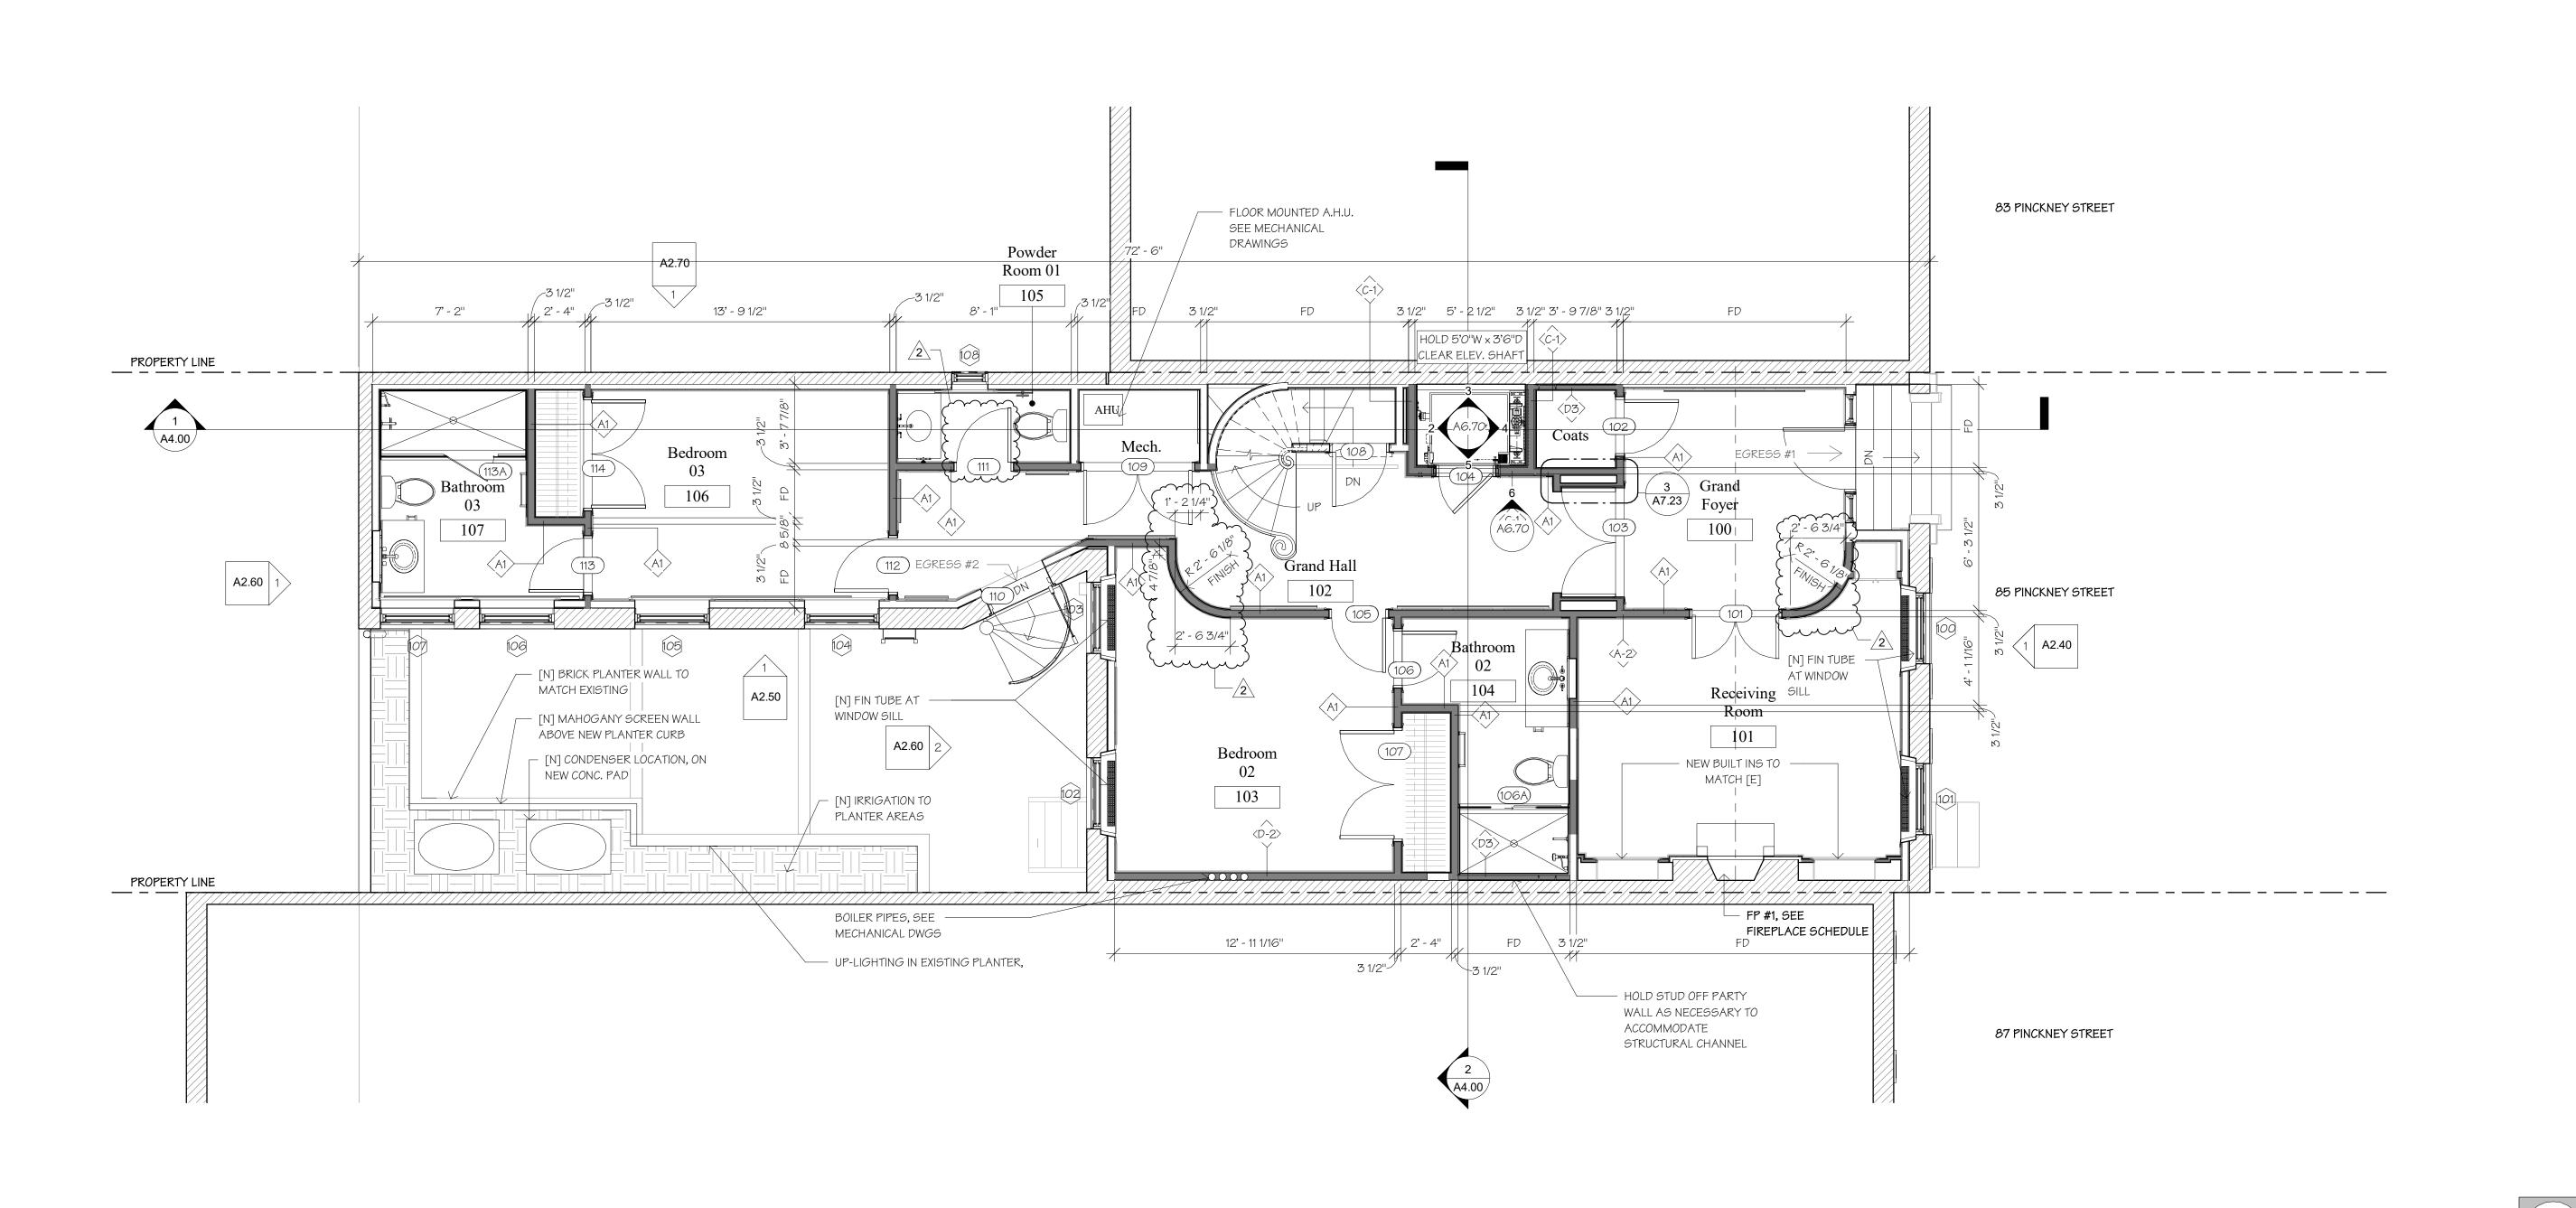


First Floor Plan

1/4" = 1'-0"

GENERAL CONSTRUCTION NOTES

- 1. TYPICAL WALL ASSEMBLIES:
- A. UNLESS OTHERWISE NOTED, ALL NEW AND/OR PATCHED INTERIOR WALL CONSTRUCTION SHALL BE 2" X 4" (UNLESS OTHERWISE NOTED, SEE PLAN) WOOD STUDS @ 16" O.C. WITH 1/2" GWB AND 1/8" SKIM COAT PLASTER FINISH ON BOTH SIDES OF STUDS, TYP. REFER TO FINISH SCHEDULE FOR TRIM & WALL FINISHES
- 2. G.C. SHALL BE RESPONSIBLE FOR PROVIDING WOOD BLOCKING AS REQUIRED FOR ALL ITEMS INCLUDING BUT NOT LIMITED TO CLOSET POLES, BUILT-INS, CABINETS SHELVING, BATHROOM ACCESSORIES AND DECORATIVE LIGHTING.
- 3. ALL NEW WALL CONSTRUCTION AND/OR WALL, CEILING, AND FLOOR INFILL THAT TIES INTO EXISTING CONSTRUCTION SHALL BE FURRED OUT AS REQUIRED TO ALIGN WITH EXISTING ADJACENT OR ABUTTING. ALL SEAMS AND JOINTS SHALL BE FULLY CONCEALED, TYPICAL THROUGHOUT.
- PATCHED WOOD FLOORING SHALL BE TOOTHED INTO EXISTING ADJACENT FLOORING, TYPICAL. THROUGHOUT U.N.O
- ALL GWB AT NON SHOWER WET WALLS SHALL BE MOISTURE RESISTANT WITH 1/8" SKIM COAT PLASTER FINISH, ALL SHOWER WALLS TO HAVE CEMENTATIOUS BACKER BOARD
- SEE TYPICAL WALL TYPE SHEET AND PLANS FOR WALL INSULATION INFORMATION.
- ALL FLOORS TO HAVE 6" MINIMUM MINERAL WOOL BATT ACOUSTIC INSULATION
- INTERIOR PAINTING SHALL INCLUDE ALL PREP WORK, ONE COAT PRIMER, AND TWO COATS FINISH. WALLS AND CEILINGS SHALL BE LATEX, U.N.O. AT ALL STONE/TILE WORK, G.C. SHALL FULLY COORDINATE ALL JOINT AND SEAM LOCATIONS WITH ARCHITECT PRIOR TO CONSTRUCTION. ALL TILE TO BE PROVIDED AND INSTALLED BY G.C. PER OWNER'S SELECTIONS.
- 10. AT ALL CLOSETS AND COAT CLOSETS, DASHED LINE INDICATES SHELF WITH ROD UNLESS OTHERWISE DETAILED.
- 11. G.C. IS RESPONSIBLE FOR REPAIRS FOR ANY DAMAGE TO NEW OR EXISTING ITEMS DUE TO CONSTRUCTION WORK, TYPICAL. FULLY PROTECT EXISTING WOOD FLOOR FINISH TO REMAIN DURING CONSTRUCTION. CONTRACTOR IS FULLY RESPONSIBLE FOR REPAIRING ANY DAMAGES, NICKS,
- REFER TO ALL DRAWINGS, SCHEDULES, ALLOWANCES, DETAILS, AND ALL NOTES FOR SCOPE OF WORK. ANY ALLOWANCES PROVIDED ARE FOR MATERIALS ONLY, UNLESS OTHERWISE NOTED. ALL LABOR SHALL BE CARRIED IN BASE BID, TYPICAL.
- ALL CLOSETS SHALL BE 2'-0" DEEP UNLESS OTHERWISE NOTED. PROVIDE ROD AND SHELF AT ALL NEW CLOSETS
- UNLESS OTHERWISE NOTED, DOOR JAMBS SHALL BE LOCATED 5" FROM ADJACENT WALL AND DOOR JAMB (FRAME TO FRAME)
- LEVEL ALL SUBFLOORS
- REPAIR AND REPAINT EXISTING INTERIOR SHUTTERS
- ALL FURRED EXTERIOR (AND PARTY) WALL CAVITIES TO BE FILLED WITH OPEN CELL INSULATION; SEE WALL TYPES.
- 18. PROVIDE ALL NEW WINDOW HARDWARE; SEE HARDWARE SCHEDULE

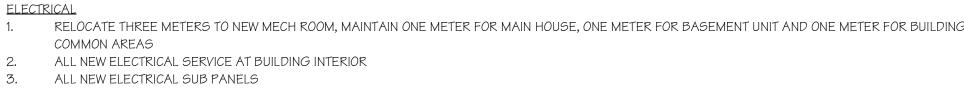

<u>AV</u>-PER AV CONSULTANT

5. MOTORIZED SHADES

1. LIGHTING CONTROL SYSTEM

2. FULL BUILDING WIFI COVERAGE

4. TELEVISION DISTRIBUTION SYSTEM

- ALL NEW ELECTRICAL SUB PANELS
- ALL NEW ELECTRICAL WIRING

TYPICAL PLAN NOTES

- ALL NEW ELECTRICAL DEVICES
- ALL NEW ADDITIONAL ELECTRICAL DEVICES REQUIRED BY CODE
- SMOKE/CO DETECTORS HARD WIRED WITH BATTERY BACKUP
- PROVIDE JAMB SWITCHES AT ALL CLOSET DOORS, UNLESS OTHERWISE NOTED
- ELECTRIC RADIANT HEAT IN HIS AND HERS BATHROOMS
- RELOCATE WATER METER (AND BOOSTER UNIT) TO NEW MECH ROOM, PROVIDE FOR FUTURE SP SIDE SUB METER TO BASEMENT UNIT
- ALL NEW HOT AND COLD WATER SUPPLIES
- ALL NEW DRAIN LINES AND DRAIN STACKS AT BUILDING INTERIOR
- ALL NEW DOMESTIC WATER HEATING EQUIPMENT ALL NEW AREA HEATING WATER HEATING EQUIPMENT
- ALL NEW PLUMBING FIXTURES
- ALL NEW ADDITIONAL PLUMBING DEVICES REQUIRED BY CODE ALL NEW GAS LINES AT BUILDING INTERIOR
- NEW WATER SOFTENER, SUMP PUMP AND PRESSURE BOOSTER PUMP <u>MECHANICAL</u>
- ALL NEW HEATING AND COOLING EQUIPMENT AT INTERIOR OF BUILDING ALL NEW DUCT, INSULATE PER CODE

ALL NEW CONDENSER/HEAT PUMP AT EXTERIOR OF BUILDING

- ALL NEW HEATING AND COOLING EQUIPMENT PLUMBING CONNECTIONS ALL NEW HEATING AND COOLING ELECTRICAL CONNECTIONS NEW ELEVATOR VENTILATION
- NEW GAS LOG INSERTS WHERE NOTED, INSTALL NEW CONCENTRIC CHIMNEY LINERS THESE LOCATIONS SUPPLY GRILLES TO BE TITUS 301FL, RETURN GRILLES TO BE TITUS 350FL
- ALL NEW SPRINKLER NFPA 13 SYSTEM
- ALL NEW FIRE ALARM SYSTEM
- NEW DEDICATED 1 1/2" (OR 2") WATER SUPPLY LINE FROM STREET MAIN TO BUILDING

NEW ROPED HYDRAULIC ELEVATOR AND ASSOCIATED EQUIPMENT IN ENLARGED EXISTING SHAFT

A.F.F. ABOVE FINISHED FLOOR NEW WALL GENERAL CONTRACTOR EXISTING WALL TO REMAIN VERIFY IN FIELD EXTERIOR ELEVATION TAG FIELD DIMENSION EXISTING MASONRY WALL TO REMAIN WALL TYPE; REFER TO A4.10 WALL TO BE DEMOLISHED 3. BASIC TELEPHONE SYSTEM WITH ENTRY DOOR INTERCOM CONNECTIVITY FLOOR TYPE; REFER TO A4.11 - DETAIL# Room name INTERIOR ELEVATION TAG 101 ROOM TAG WINDOW TAG; REFER TO WINDOW 101 DOOR TAG; REFER TO DOOR SCHEDULE ENLARGED PLAN KEY DIMENSION TO FACE OF STUD

— DETAIL#

PLAN LEGEND

NEW DOOR



Project:

85 Pinckney St

85 Pinckney Street Boston, MA

Issue Dates and Revisions:

2 ASI-002

10/23/2018 11/01/2018 Bid Set 12/12/2018 50% CD Set 100% CD Set 01/11/2019 02/14/2019 ASI-001

TBD

General Notes: General Contractor shall make all Subcontractors and All work shall be performed in compliance with all applicable Local, State and National Building, Life Safety and Electrical Codes.

General Contractor shall be responsible for securing all permits as necessary for the completion of work shown throughout the Contract Documents.

General Contractor shall lay out in the field the entire

constructing any part, and shall verify all existing conditions and locations before proceeding.

Failure to verify dimensions and conditions before proceeding may subject the General Contractor to the required removal of completed work at General Contractor cost, if a discrepancy which could have been discovered causes modifications to the plans. General Contractor shall coordinate the dimensiona requirements between the work of the various trades.

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Regardless of whether or not an item is shown or specified, General Contractor shall provide said item if it is necessary for the proper installation or function of an item shown or specified. Suppliers and Subcontractors shall inform the General Contractor of their requirements for the work of other trades, which may not be indicated,

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ROOF DRAIN

CENTERLINE

UNLESS NOTED OTHERWISE



Author

Checker


Drawing Title:

First Floor Plan

Drawn:

Checked:

Project Number:

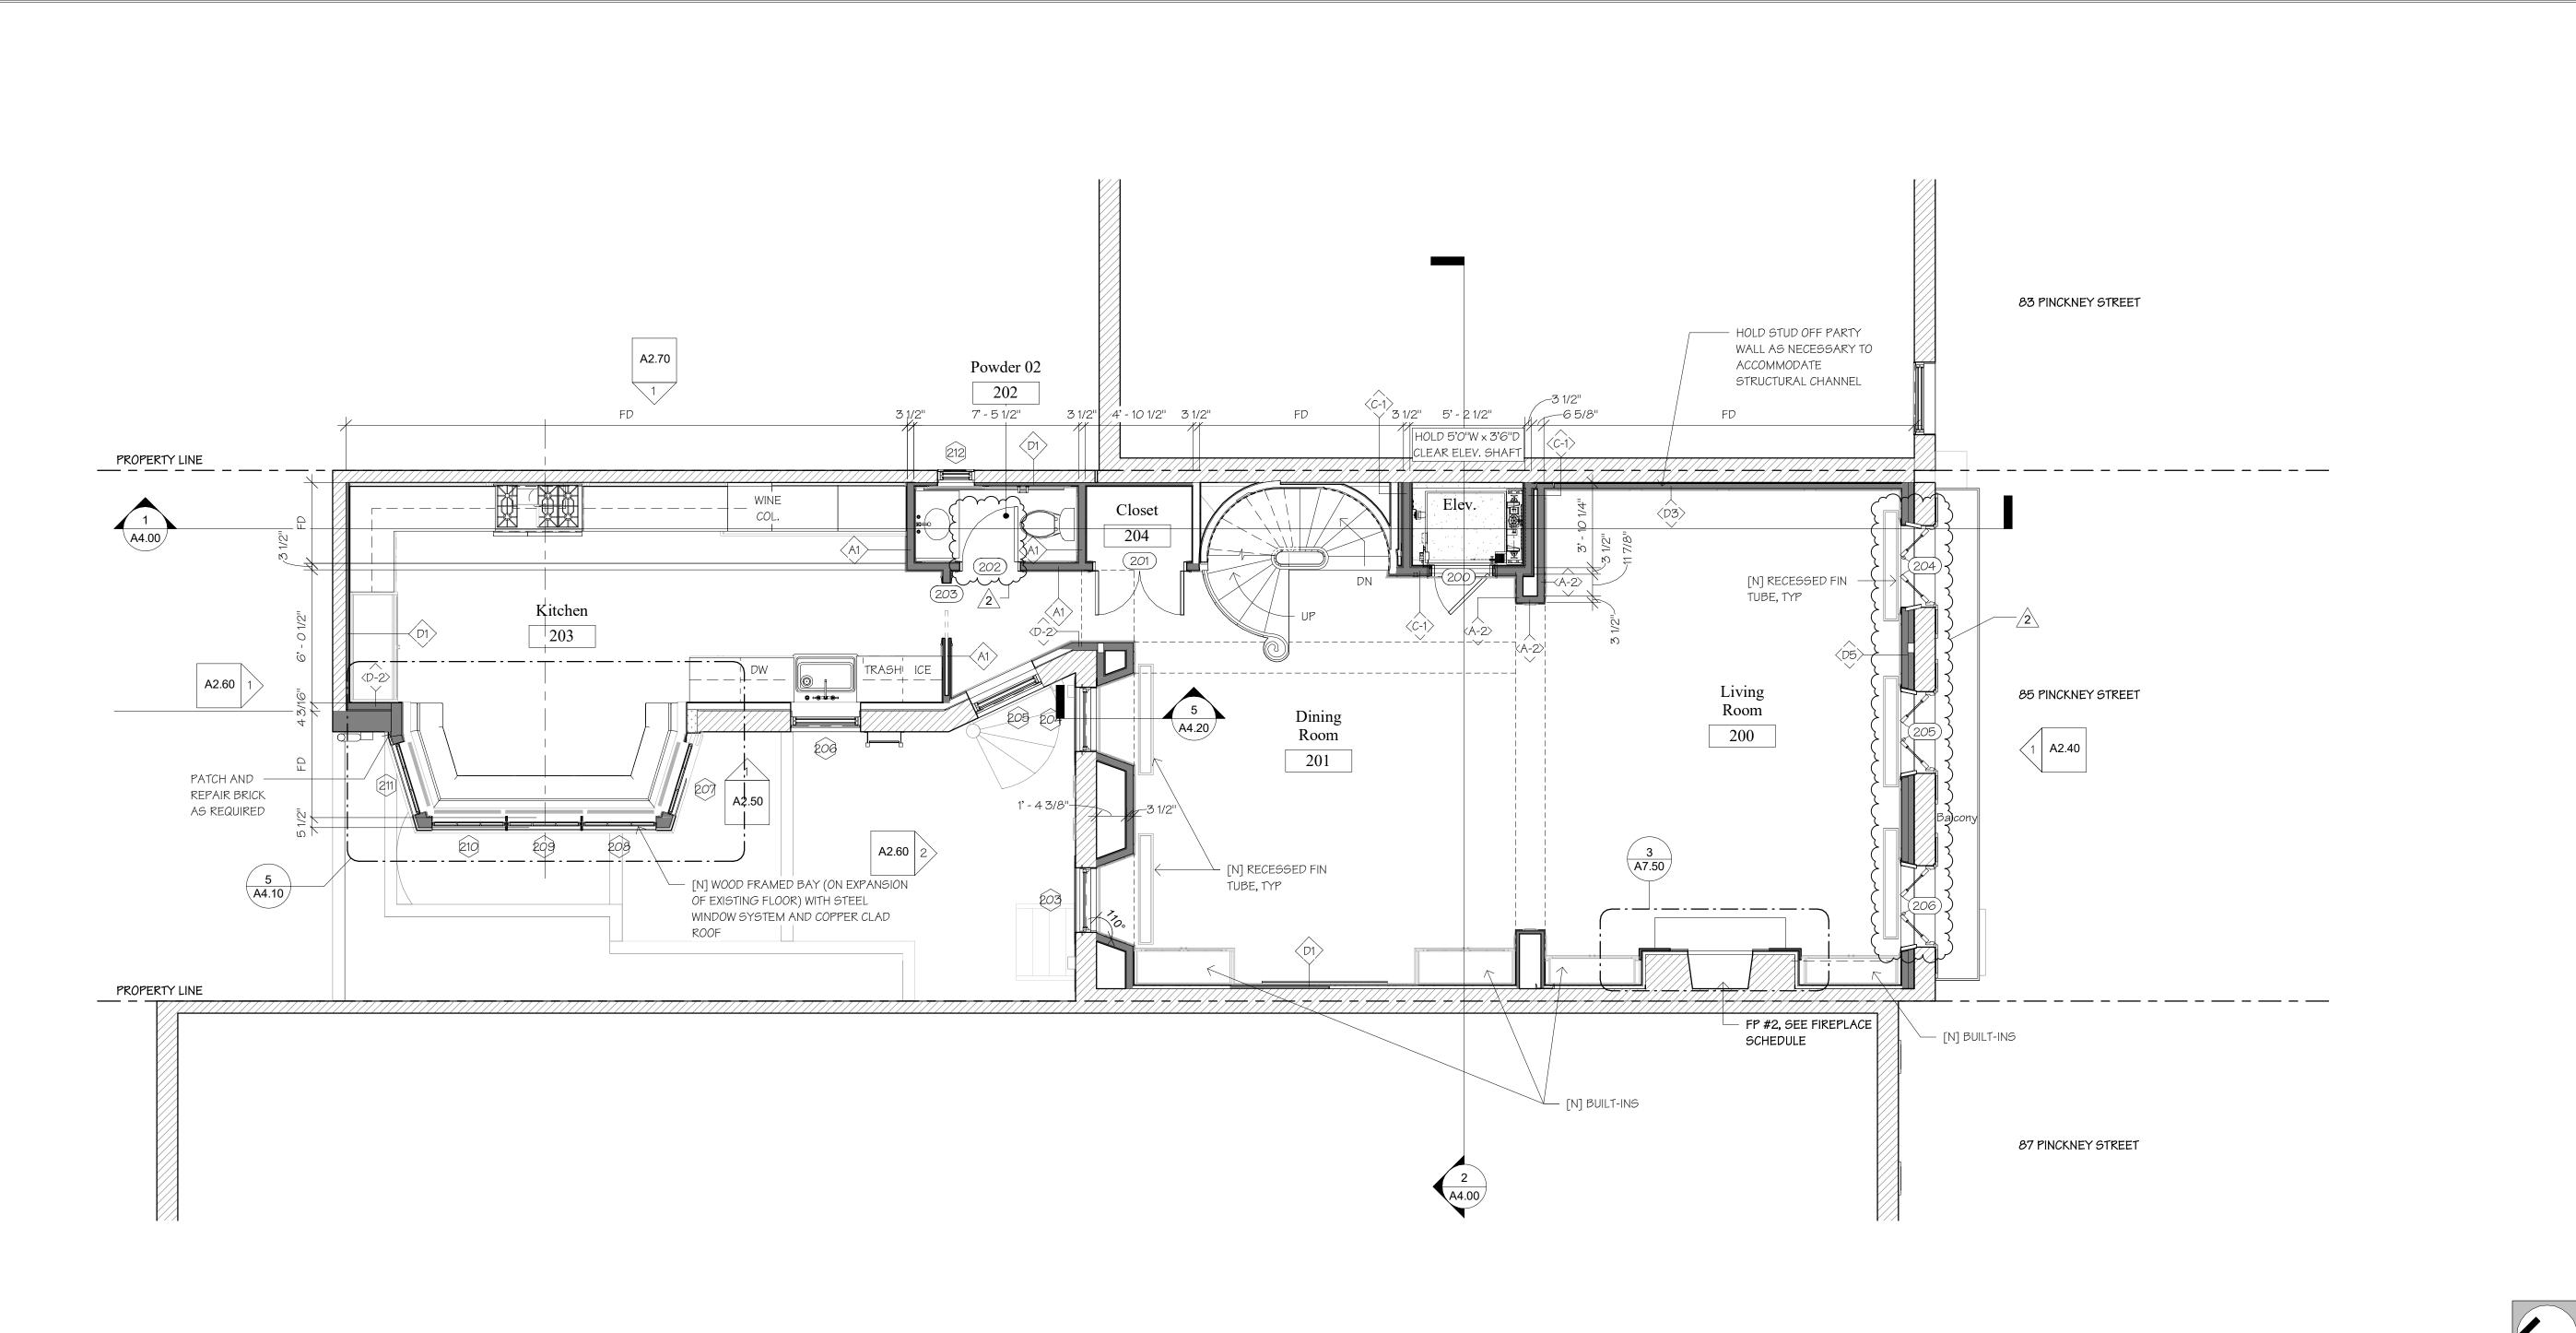

Second Floor Plan 1/4" = 1'-0"

GENERAL CONSTRUCTION NOTES

A. UNLESS OTHERWISE NOTED, ALL NEW AND/OR PATCHED INTERIOR WALL CONSTRUCTION SHALL BE 2" X 4" (UNLESS OTHERWISE NOTED, SEE PLAN) WOOD STUDS @ 16" O.C. WITH 1/2" GWB AND 1/8" SKIM COAT PLASTER FINISH ON BOTH SIDES OF STUDS, TYP. REFER TO FINISH SCHEDULE FOR TRIM & WALL FINISHES

2. G.C. SHALL BE RESPONSIBLE FOR PROVIDING WOOD BLOCKING AS REQUIRED FOR ALL ITEMS INCLUDING BUT NOT LIMITED TO CLOSET POLES, BUILT-INS, CABINETS SHELVING, BATHROOM ACCESSORIES AND DECORATIVE LIGHTING.

3. ALL NEW WALL CONSTRUCTION AND/OR WALL, CEILING, AND FLOOR INFILL THAT TIES INTO EXISTING CONSTRUCTION SHALL BE FURRED OUT AS REQUIRED TO ALIGN WITH EXISTING ADJACENT OR ABUTTING. ALL SEAMS AND JOINTS SHALL BE FULLY CONCEALED, TYPICAL THROUGHOUT. PATCHED WOOD FLOORING SHALL BE TOOTHED INTO EXISTING ADJACENT FLOORING, TYPICAL. THROUGHOUT U.N.O.

ALL GWB AT NON SHOWER WET WALLS SHALL BE MOISTURE RESISTANT WITH 1/8" SKIM COAT PLASTER FINISH, ALL SHOWER WALLS TO HAVE CEMENTATIOUS BACKER BOARD

SEE TYPICAL WALL TYPE SHEET AND PLANS FOR WALL INSULATION INFORMATION.

ALL FLOORS TO HAVE 6" MINIMUM MINERAL WOOL BATT ACOUSTIC INSULATION

INTERIOR PAINTING SHALL INCLUDE ALL PREP WORK, ONE COAT PRIMER, AND TWO COATS FINISH. WALLS AND CEILINGS SHALL BE LATEX, U.N.O. AT ALL STONE/TILE WORK, G.C. SHALL FULLY COORDINATE ALL JOINT AND SEAM LOCATIONS WITH ARCHITECT PRIOR TO CONSTRUCTION. ALL TILE TO

BE PROVIDED AND INSTALLED BY G.C. PER OWNER'S SELECTIONS.

10. AT ALL CLOSETS AND COAT CLOSETS, DASHED LINE INDICATES SHELF WITH ROD UNLESS OTHERWISE DETAILED.

G.C. IS RESPONSIBLE FOR REPAIRS FOR ANY DAMAGE TO NEW OR EXISTING ITEMS DUE TO CONSTRUCTION WORK, TYPICAL. FULLY PROTECT EXISTING WOOD FLOOR FINISH TO REMAIN DURING CONSTRUCTION. CONTRACTOR IS FULLY RESPONSIBLE FOR REPAIRING ANY DAMAGES, NICKS,

REFER TO ALL DRAWINGS, SCHEDULES, ALLOWANCES, DETAILS, AND ALL NOTES FOR SCOPE OF WORK. ANY ALLOWANCES PROVIDED ARE FOR MATERIALS ONLY, UNLESS OTHERWISE NOTED. ALL LABOR SHALL BE CARRIED IN BASE BID, TYPICAL.

ALL CLOSETS SHALL BE 2'-O" DEEP UNLESS OTHERWISE NOTED. PROVIDE ROD AND SHELF AT ALL NEW CLOSETS.

UNLESS OTHERWISE NOTED, DOOR JAMBS SHALL BE LOCATED 5" FROM ADJACENT WALL AND DOOR JAMB (FRAME TO FRAME)

LEVEL ALL SUBFLOORS

16. REPAIR AND REPAINT EXISTING INTERIOR SHUTTERS

17. ALL FURRED EXTERIOR (AND PARTY) WALL CAVITIES TO BE FILLED WITH OPEN CELL INSULATION; SEE WALL TYPES.

18. PROVIDE ALL NEW WINDOW HARDWARE; SEE HARDWARE SCHEDULE

TYPICAL PLAN NOTES ELECTRICAL

1. RELOCATE THREE METERS TO NEW MECH ROOM, MAINTAIN ONE METER FOR MAIN HOUSE, ONE METER FOR BASEMENT UNIT AND ONE METER FOR BUILDING COMMON AREAS

<u>AV</u>-PER AV CONSULTANT

5. MOTORIZED SHADES

1. LIGHTING CONTROL SYSTEM

2. FULL BUILDING WIFI COVERAGE

4. TELEVISION DISTRIBUTION SYSTEM

3. BASIC TELEPHONE SYSTEM WITH ENTRY DOOR INTERCOM CONNECTIVITY

ALL NEW ELECTRICAL SERVICE AT BUILDING INTERIOR

ALL NEW ELECTRICAL SUB PANELS

ALL NEW ELECTRICAL WIRING ALL NEW ELECTRICAL DEVICES

ALL NEW ADDITIONAL ELECTRICAL DEVICES REQUIRED BY CODE SMOKE/CO DETECTORS HARD WIRED WITH BATTERY BACKUP

PROVIDE JAMB SWITCHES AT ALL CLOSET DOORS, UNLESS OTHERWISE NOTED ELECTRIC RADIANT HEAT IN HIS AND HERS BATHROOMS

RELOCATE WATER METER (AND BOOSTER UNIT) TO NEW MECH ROOM, PROVIDE FOR FUTURE SP SIDE SUB METER TO BASEMENT UNIT

ALL NEW HOT AND COLD WATER SUPPLIES ALL NEW DRAIN LINES AND DRAIN STACKS AT BUILDING INTERIOR

ALL NEW DOMESTIC WATER HEATING EQUIPMENT

ALL NEW AREA HEATING WATER HEATING EQUIPMENT ALL NEW PLUMBING FIXTURES

ALL NEW ADDITIONAL PLUMBING DEVICES REQUIRED BY CODE

ALL NEW GAS LINES AT BUILDING INTERIOR NEW WATER SOFTENER, SUMP PUMP AND PRESSURE BOOSTER PUMP

ALL NEW HEATING AND COOLING EQUIPMENT AT INTERIOR OF BUILDING


ALL NEW DUCT, INSULATE PER CODE ALL NEW CONDENSER/HEAT PUMP AT EXTERIOR OF BUILDING ALL NEW HEATING AND COOLING EQUIPMENT PLUMBING CONNECTIONS ALL NEW HEATING AND COOLING ELECTRICAL CONNECTIONS

NEW ELEVATOR VENTILATION NEW GAS LOG INSERTS WHERE NOTED, INSTALL NEW CONCENTRIC CHIMNEY LINERS THESE LOCATIONS SUPPLY GRILLES TO BE TITUS 301FL, RETURN GRILLES TO BE TITUS 350FL

ALL NEW SPRINKLER NFPA 13 SYSTEM ALL NEW FIRE ALARM SYSTEM

NEW DEDICATED 1 1/2" (OR 2") WATER SUPPLY LINE FROM STREET MAIN TO BUILDING NEW ROPED HYDRAULIC ELEVATOR AND ASSOCIATED EQUIPMENT IN ENLARGED EXISTING SHAFT

PLAN LEGEND

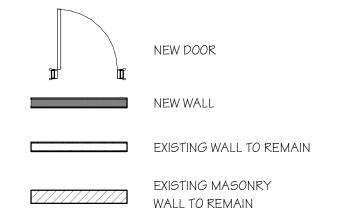



ROOM TAG


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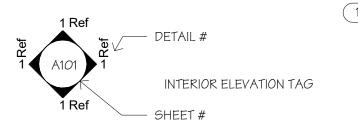
name


101



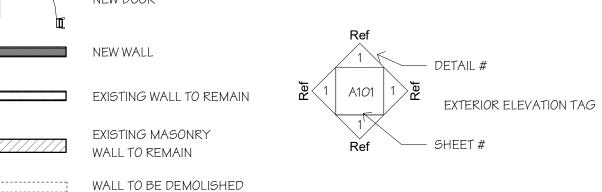

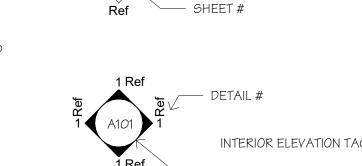

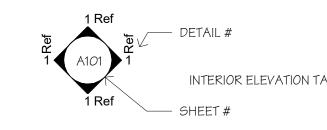

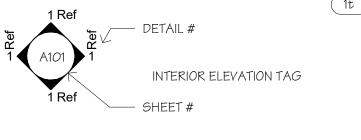

R.D.

ROOF DRAIN

CENTERLINE

VERIFY IN FIELD

FIELD DIMENSION


UNLESS NOTED OTHERWISE

ABOVE FINISHED FLOOR

GENERAL CONTRACTOR


WALL TYPE; REFER TO A4.10

FLOOR TYPE; REFER TO A4.11

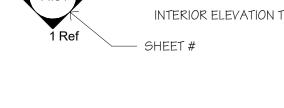





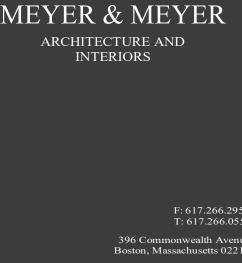

Project:

85 Pinckney St

85 Pinckney Street Boston, MA

Issue Dates and Revisions:

10/23/2018 Permit Set 11/01/2018 Bid Set 12/12/2018 50% CD Set 100% CD Set 01/11/2019 02/14/2019 ASI-001 2 ASI-002 TBD

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Author

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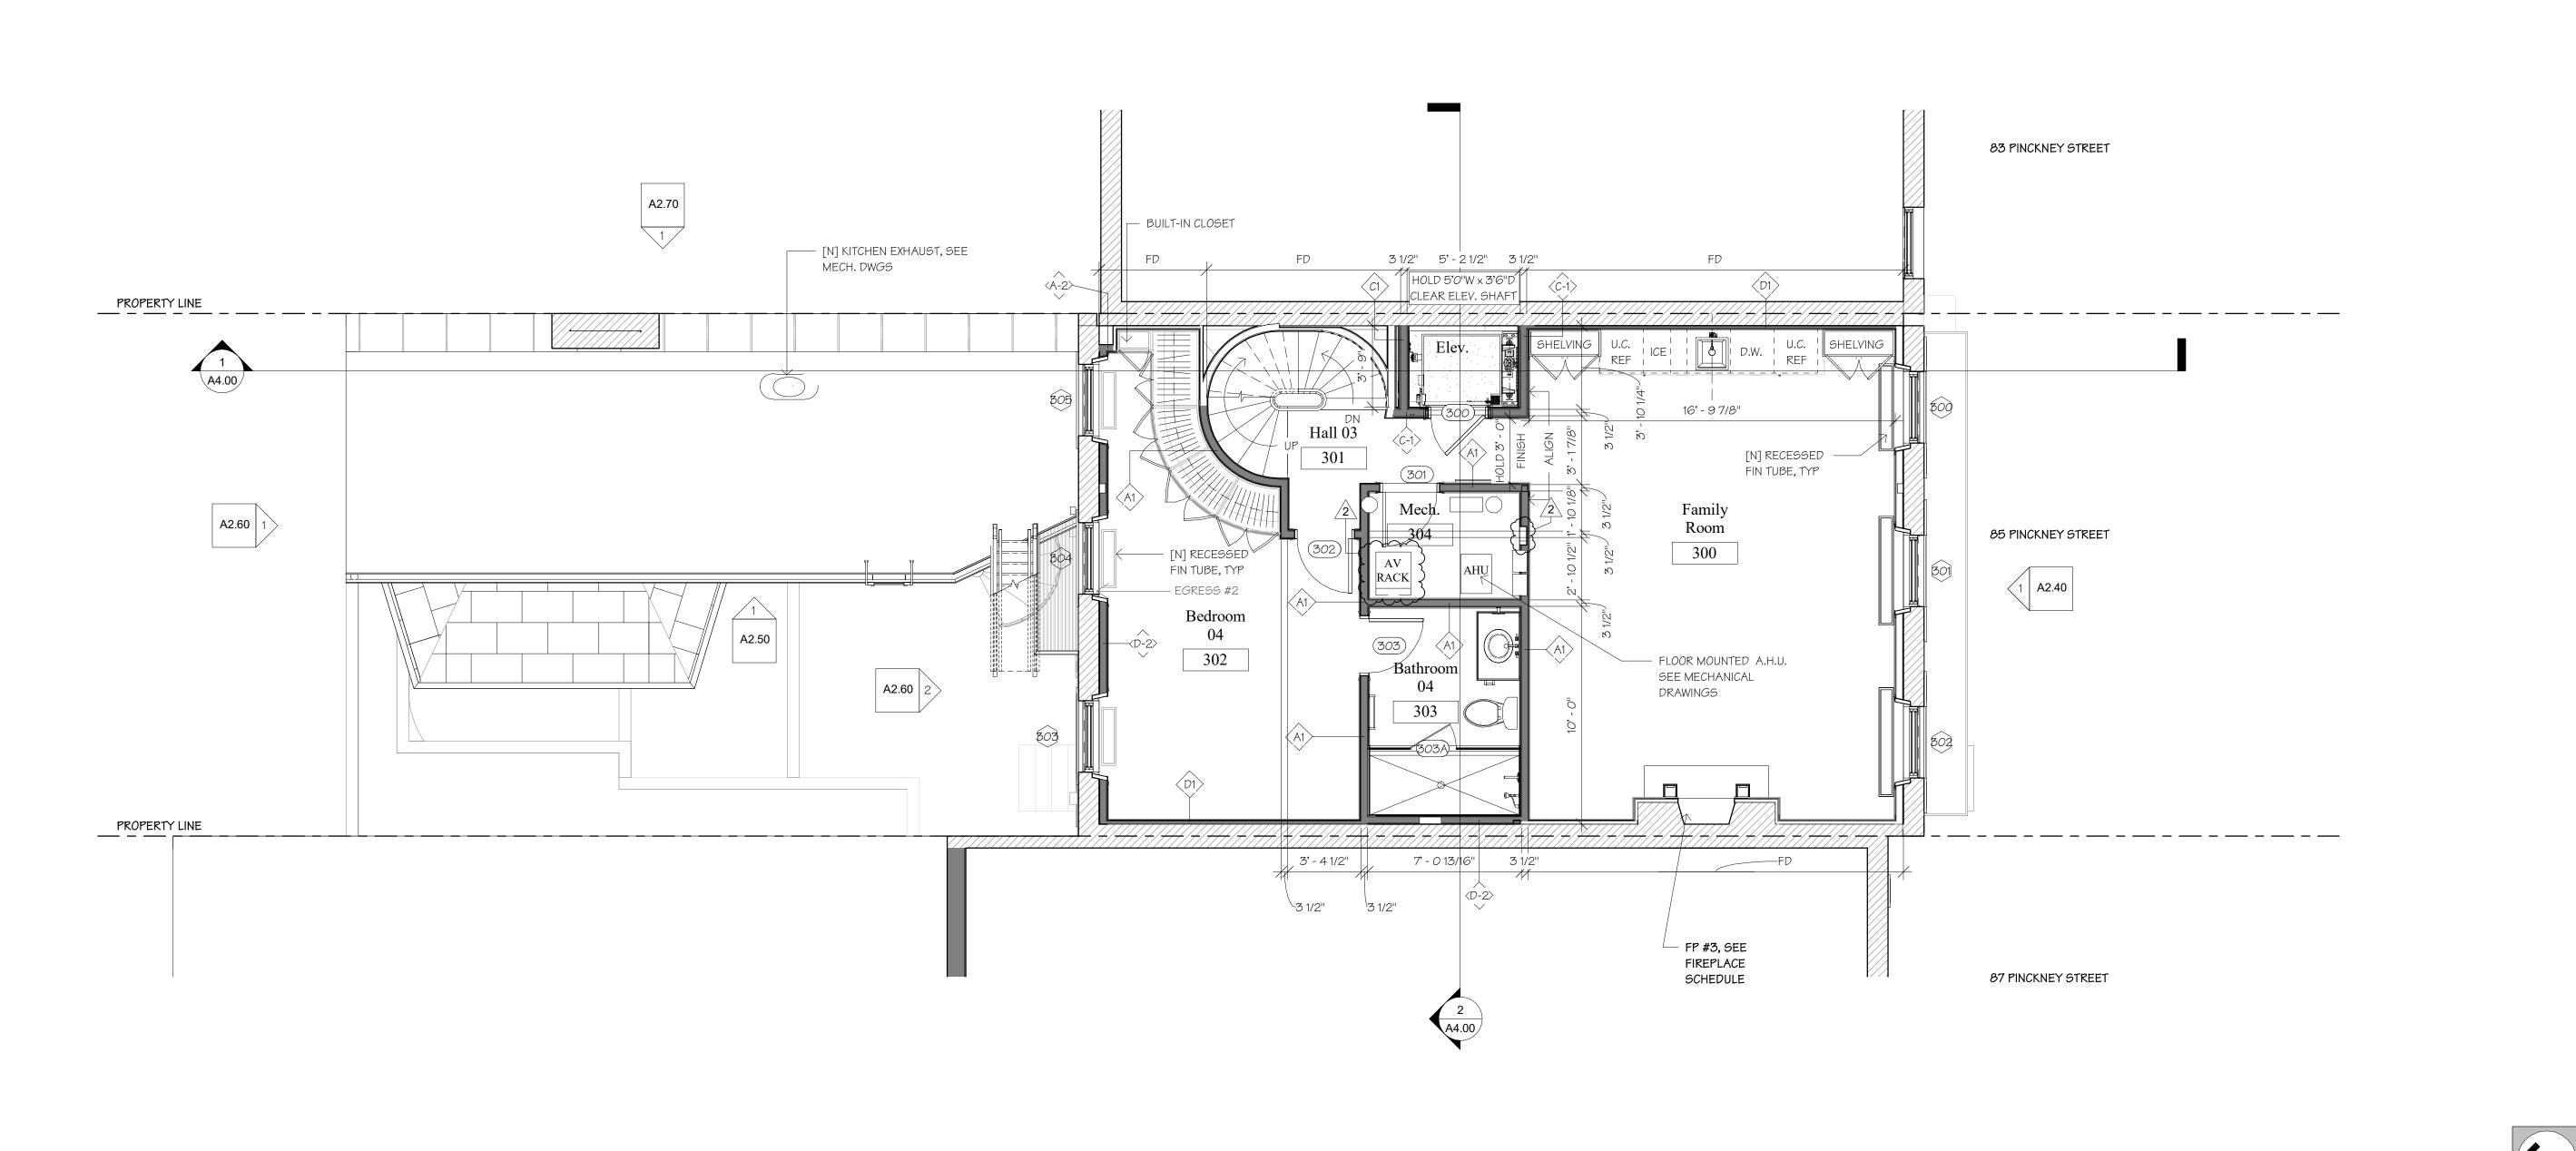
Drawing Title:

Second Floor

Drawn:

Checked:

Project Number:





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- 3. ALL NEW WALL CONSTRUCTION AND/OR WALL, CEILING, AND FLOOR INFILL THAT TIES INTO EXISTING CONSTRUCTION SHALL BE FURRED OUT AS
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FIRE PROTECTION


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NEW DEDICATED 1 1/2" (OR 2") WATER SUPPLY LINE FROM STREET MAIN TO BUILDING

NEW ROPED HYDRAULIC ELEVATOR AND ASSOCIATED EQUIPMENT IN ENLARGED EXISTING SHAFT

ALL NEW FIRE ALARM SYSTEM

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- ALL FURRED EXTERIOR (AND PARTY) WALL CAVITIES TO BE FILLED WITH OPEN CELL INSULATION; SEE WALL TYPES.
- 18. PROVIDE ALL NEW WINDOW HARDWARE; SEE HARDWARE SCHEDULE

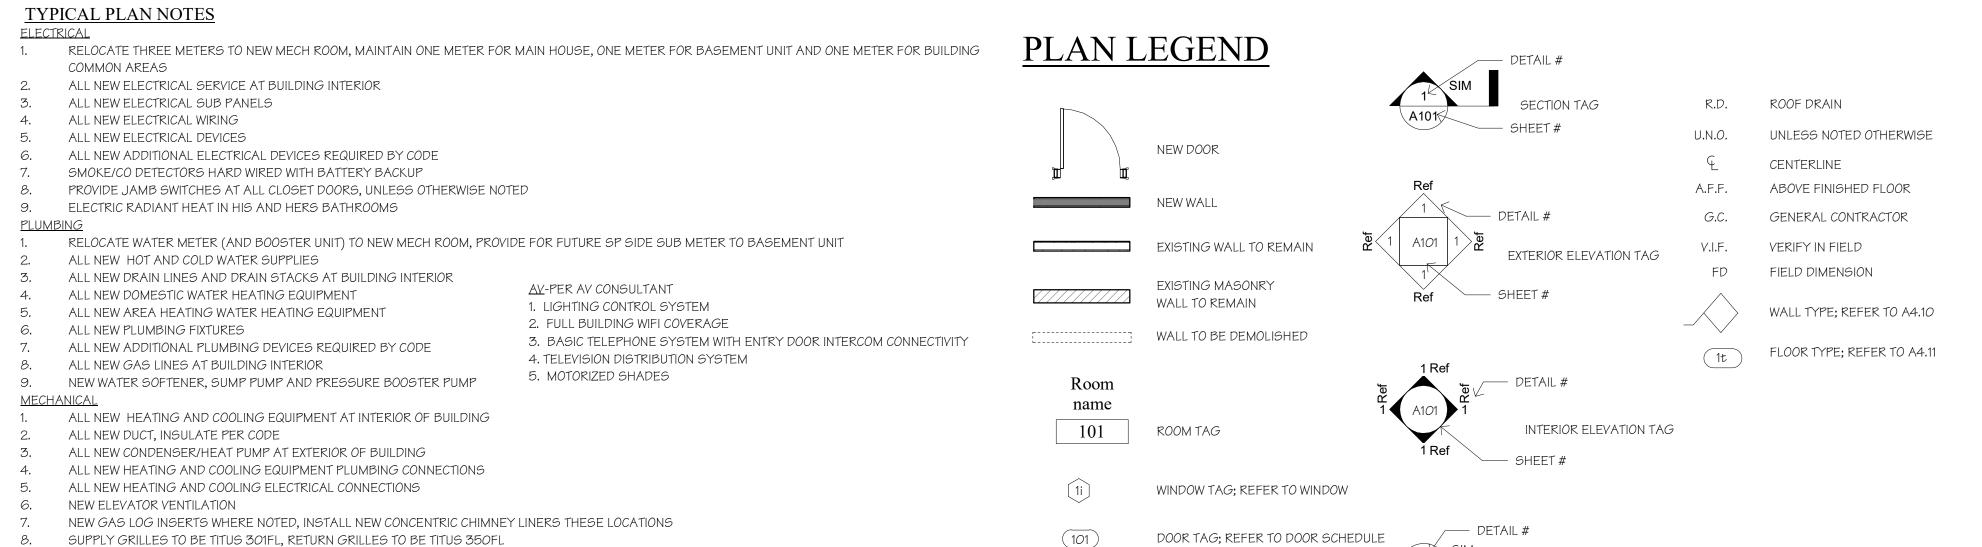

DIMENSION TO FACE OF STUD

MEYER & MEYER ARCHITECTURE AND INTERIORS F: 617.266.29: T: 617.266.05

Project:

2 ASI-002

85 Pinckney St

85 Pinckney Street Boston, MA

Issue Dates and Revisions: 10/23/2018 Permit Set 11/01/2018 Bid Set 12/12/2018 50% CD Set 100% CD Set 01/11/2019 02/14/2019 ASI-001

TBD

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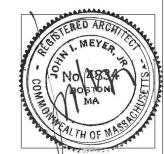
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Author

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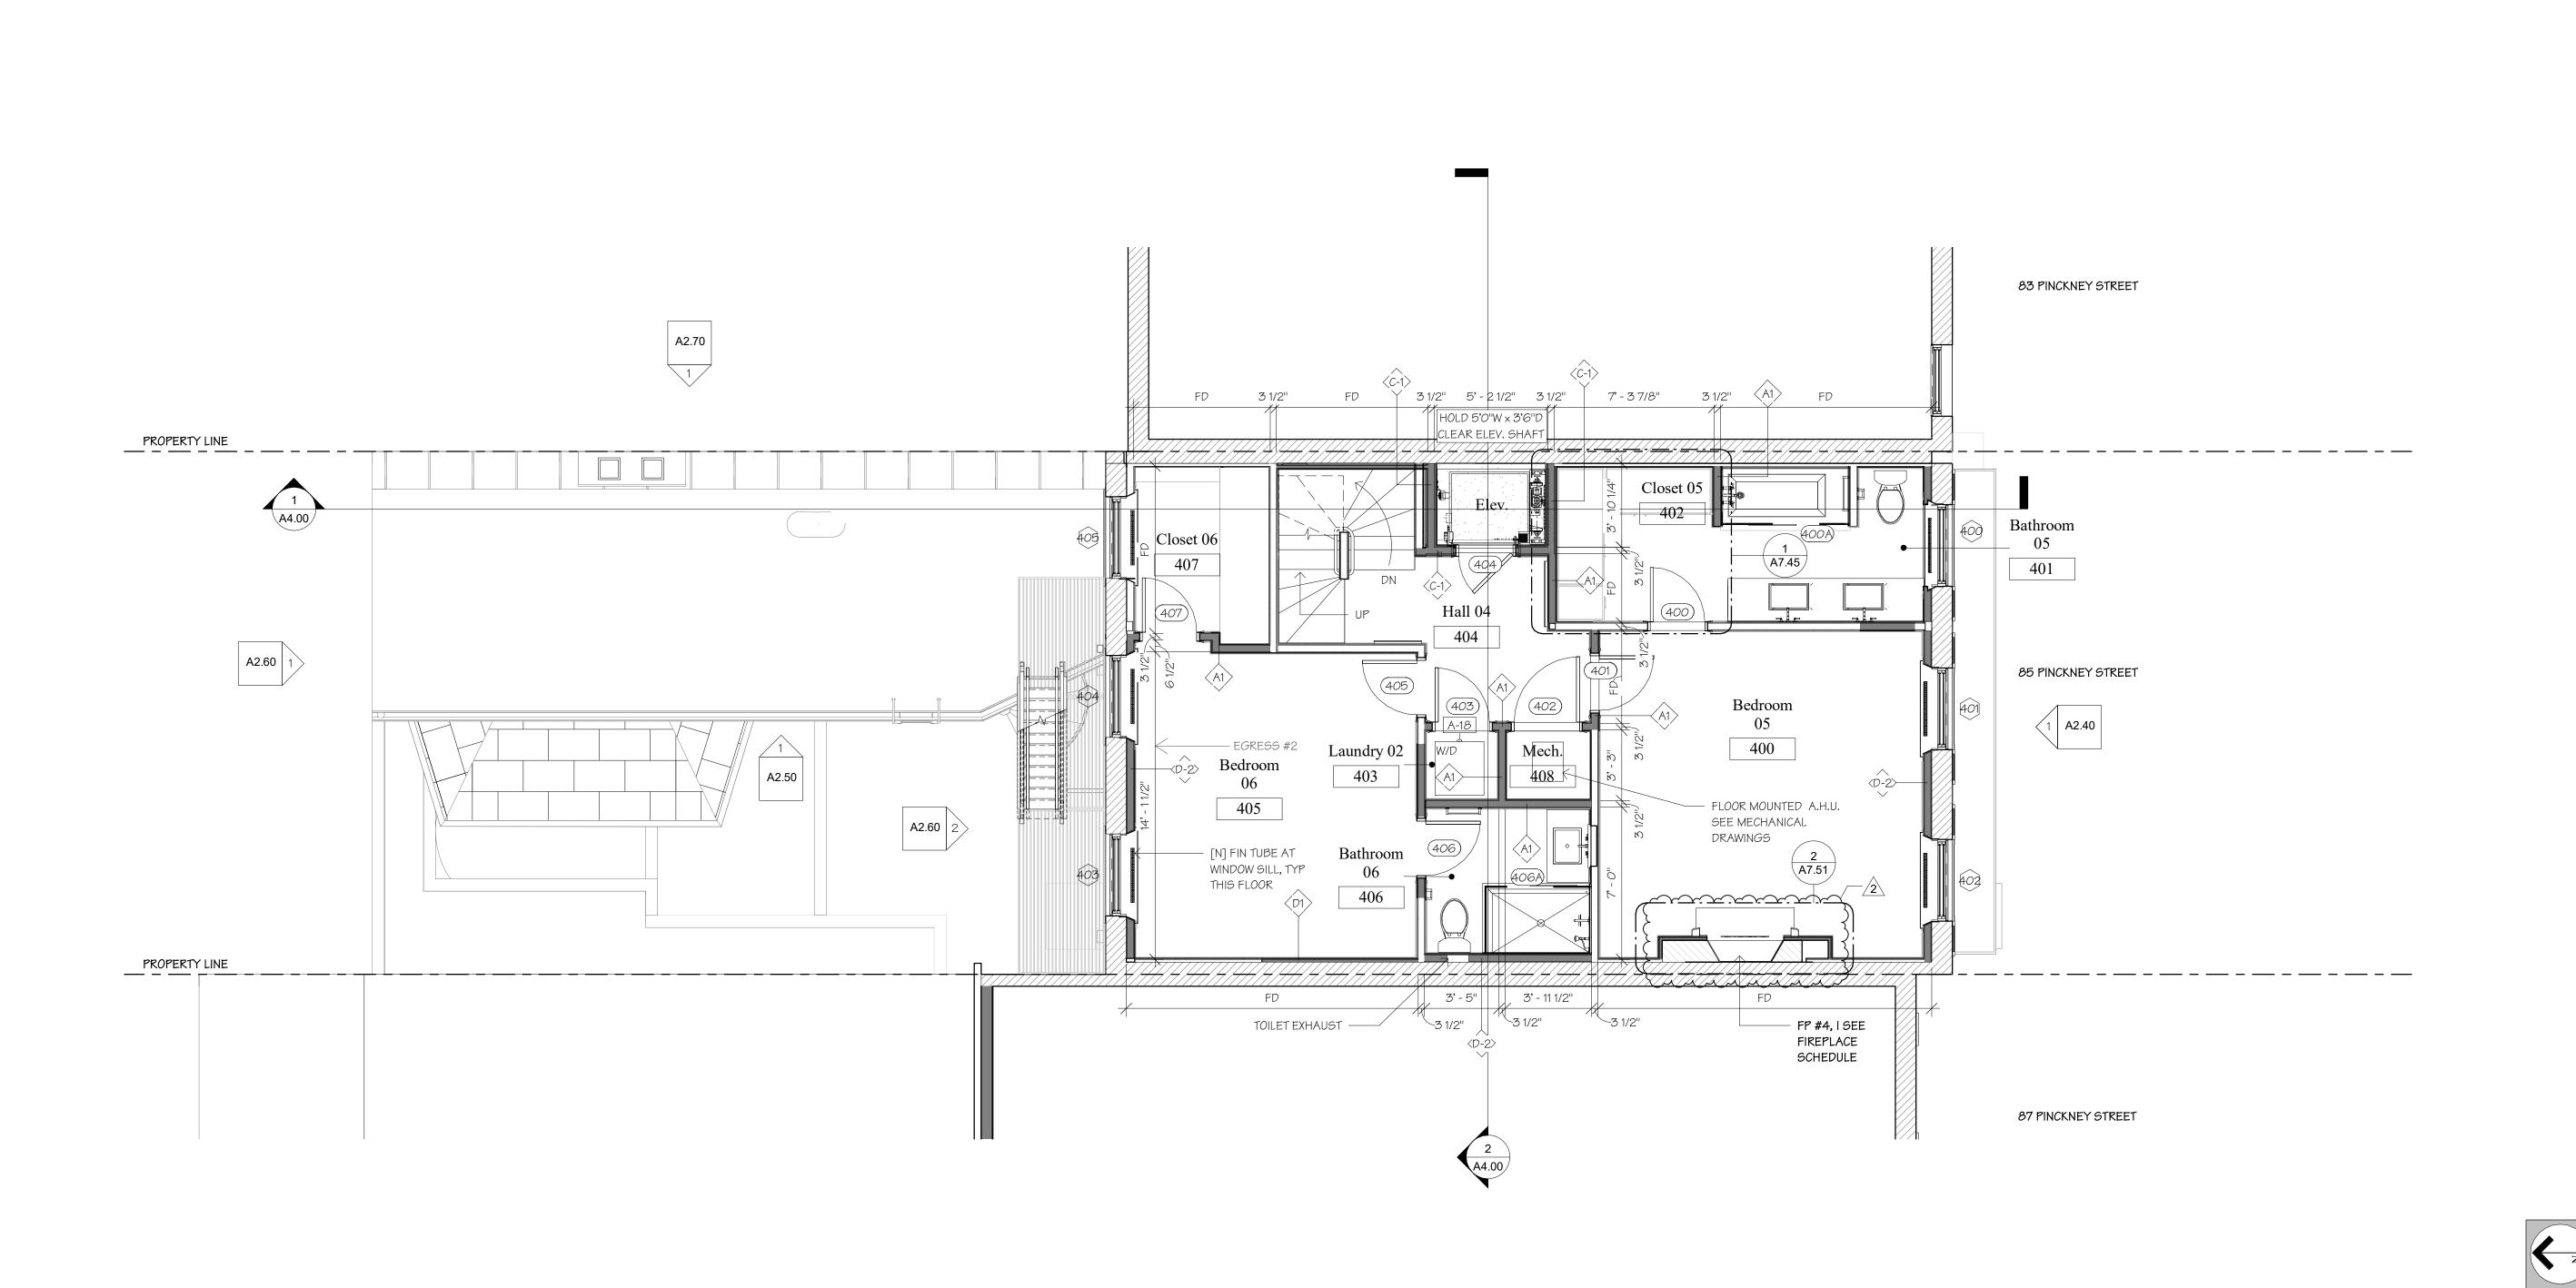
Drawing Title: Third Floor Plan

Checked:

ENLARGED PLAN KEY

Drawn:

Project Number:



Fourth Floor Plan

1/4" = 1'-0"

GENERAL CONSTRUCTION NOTES

- 1. TYPICAL WALL ASSEMBLIES:
 - A. UNLESS OTHERWISE NOTED, ALL NEW AND/OR PATCHED INTERIOR WALL CONSTRUCTION SHALL BE 2" X 4" (UNLESS OTHERWISE NOTED, SEE PLAN) WOOD STUDS @ 16" O.C. WITH 1/2" GWB AND 1/8" SKIM COAT PLASTER FINISH ON BOTH SIDES OF STUDS, TYP. REFER TO FINISH SCHEDULE FOR TRIM & WALL FINISHES
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- SCRATCHES. 12. REFER TO ALL DRAWINGS, SCHEDULES, ALLOWANCES, DETAILS, AND ALL NOTES FOR SCOPE OF WORK. ANY ALLOWANCES PROVIDED ARE FOR
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- UNLESS OTHERWISE NOTED, DOOR JAMBS SHALL BE LOCATED 5" FROM ADJACENT WALL AND DOOR JAMB (FRAME TO FRAME)
- LEVEL ALL SUBFLOORS
- REPAIR AND REPAINT EXISTING INTERIOR SHUTTERS
- ALL FURRED EXTERIOR (AND PARTY) WALL CAVITIES TO BE FILLED WITH OPEN CELL INSULATION; SEE WALL TYPES.
- 18. PROVIDE ALL NEW WINDOW HARDWARE; SEE HARDWARE SCHEDULE

TYPICAL PLAN NOTES

ELECTRICAL 1. RELOCATE THREE METERS TO NEW MECH ROOM, MAINTAIN ONE METER FOR MAIN HOUSE, ONE METER FOR BASEMENT UNIT AND ONE METER FOR BUILDING

<u>AV</u>-PER AV CONSULTANT

5. MOTORIZED SHADES

1. LIGHTING CONTROL SYSTEM

2. FULL BUILDING WIFI COVERAGE

4. TELEVISION DISTRIBUTION SYSTEM

3. BASIC TELEPHONE SYSTEM WITH ENTRY DOOR INTERCOM CONNECTIVITY


- COMMON AREAS
- ALL NEW ELECTRICAL SERVICE AT BUILDING INTERIOR
- ALL NEW ELECTRICAL SUB PANELS
- ALL NEW ELECTRICAL WIRING
- ALL NEW ELECTRICAL DEVICES
- ALL NEW ADDITIONAL ELECTRICAL DEVICES REQUIRED BY CODE SMOKE/CO DETECTORS HARD WIRED WITH BATTERY BACKUP
- PROVIDE JAMB SWITCHES AT ALL CLOSET DOORS, UNLESS OTHERWISE NOTED
- ELECTRIC RADIANT HEAT IN HIS AND HERS BATHROOMS

RELOCATE WATER METER (AND BOOSTER UNIT) TO NEW MECH ROOM, PROVIDE FOR FUTURE SP SIDE SUB METER TO BASEMENT UNIT


- ALL NEW HOT AND COLD WATER SUPPLIES ALL NEW DRAIN LINES AND DRAIN STACKS AT BUILDING INTERIOR
- ALL NEW DOMESTIC WATER HEATING EQUIPMENT
- ALL NEW AREA HEATING WATER HEATING EQUIPMENT
- ALL NEW PLUMBING FIXTURES ALL NEW ADDITIONAL PLUMBING DEVICES REQUIRED BY CODE
- ALL NEW GAS LINES AT BUILDING INTERIOR
- NEW WATER SOFTENER, SUMP PUMP AND PRESSURE BOOSTER PUMP
- 1. ALL NEW HEATING AND COOLING EQUIPMENT AT INTERIOR OF BUILDING ALL NEW DUCT, INSULATE PER CODE
- ALL NEW CONDENSER/HEAT PUMP AT EXTERIOR OF BUILDING ALL NEW HEATING AND COOLING EQUIPMENT PLUMBING CONNECTIONS
- ALL NEW HEATING AND COOLING ELECTRICAL CONNECTIONS
- NEW ELEVATOR VENTILATION NEW GAS LOG INSERTS WHERE NOTED, INSTALL NEW CONCENTRIC CHIMNEY LINERS THESE LOCATIONS SUPPLY GRILLES TO BE TITUS 301FL, RETURN GRILLES TO BE TITUS 350FL
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1. NEW ROPED HYDRAULIC ELEVATOR AND ASSOCIATED EQUIPMENT IN ENLARGED EXISTING SHAFT


PLAN LEGEND

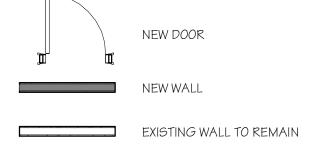

EXISTING MASONRY

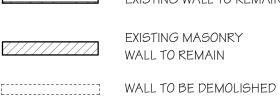

Room

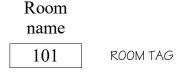












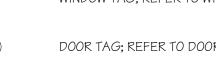

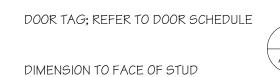

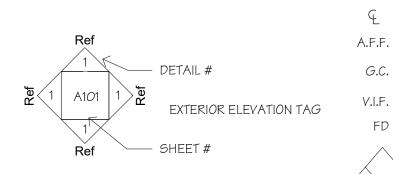

GENERAL CONTRACTOR VERIFY IN FIELD FIELD DIMENSION WALL TYPE; REFER TO A4.10

R.D.

U.N.O.

FLOOR TYPE; REFER TO A4.11

ROOF DRAIN

CENTERLINE

UNLESS NOTED OTHERWISE

ABOVE FINISHED FLOOR

INTERIOR ELEVATION TAG SHEET#

WINDOW TAG; REFER TO WINDOW



ENLARGED PLAN KEY

F: 617.266.29: T: 617.266.05 85 Pinckney St 85 Pinckney Street

MEYER & MEYER

ARCHITECTURE AND INTERIORS

Boston, MA

Issue Dates and Revisions: 10/23/2018 Permit Set 11/01/2018 Bid Set 50% CD Set 12/12/2018 100% CD Set 01/11/2019 02/14/2019 ASI-001 2 ASI-002 TBD

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Author

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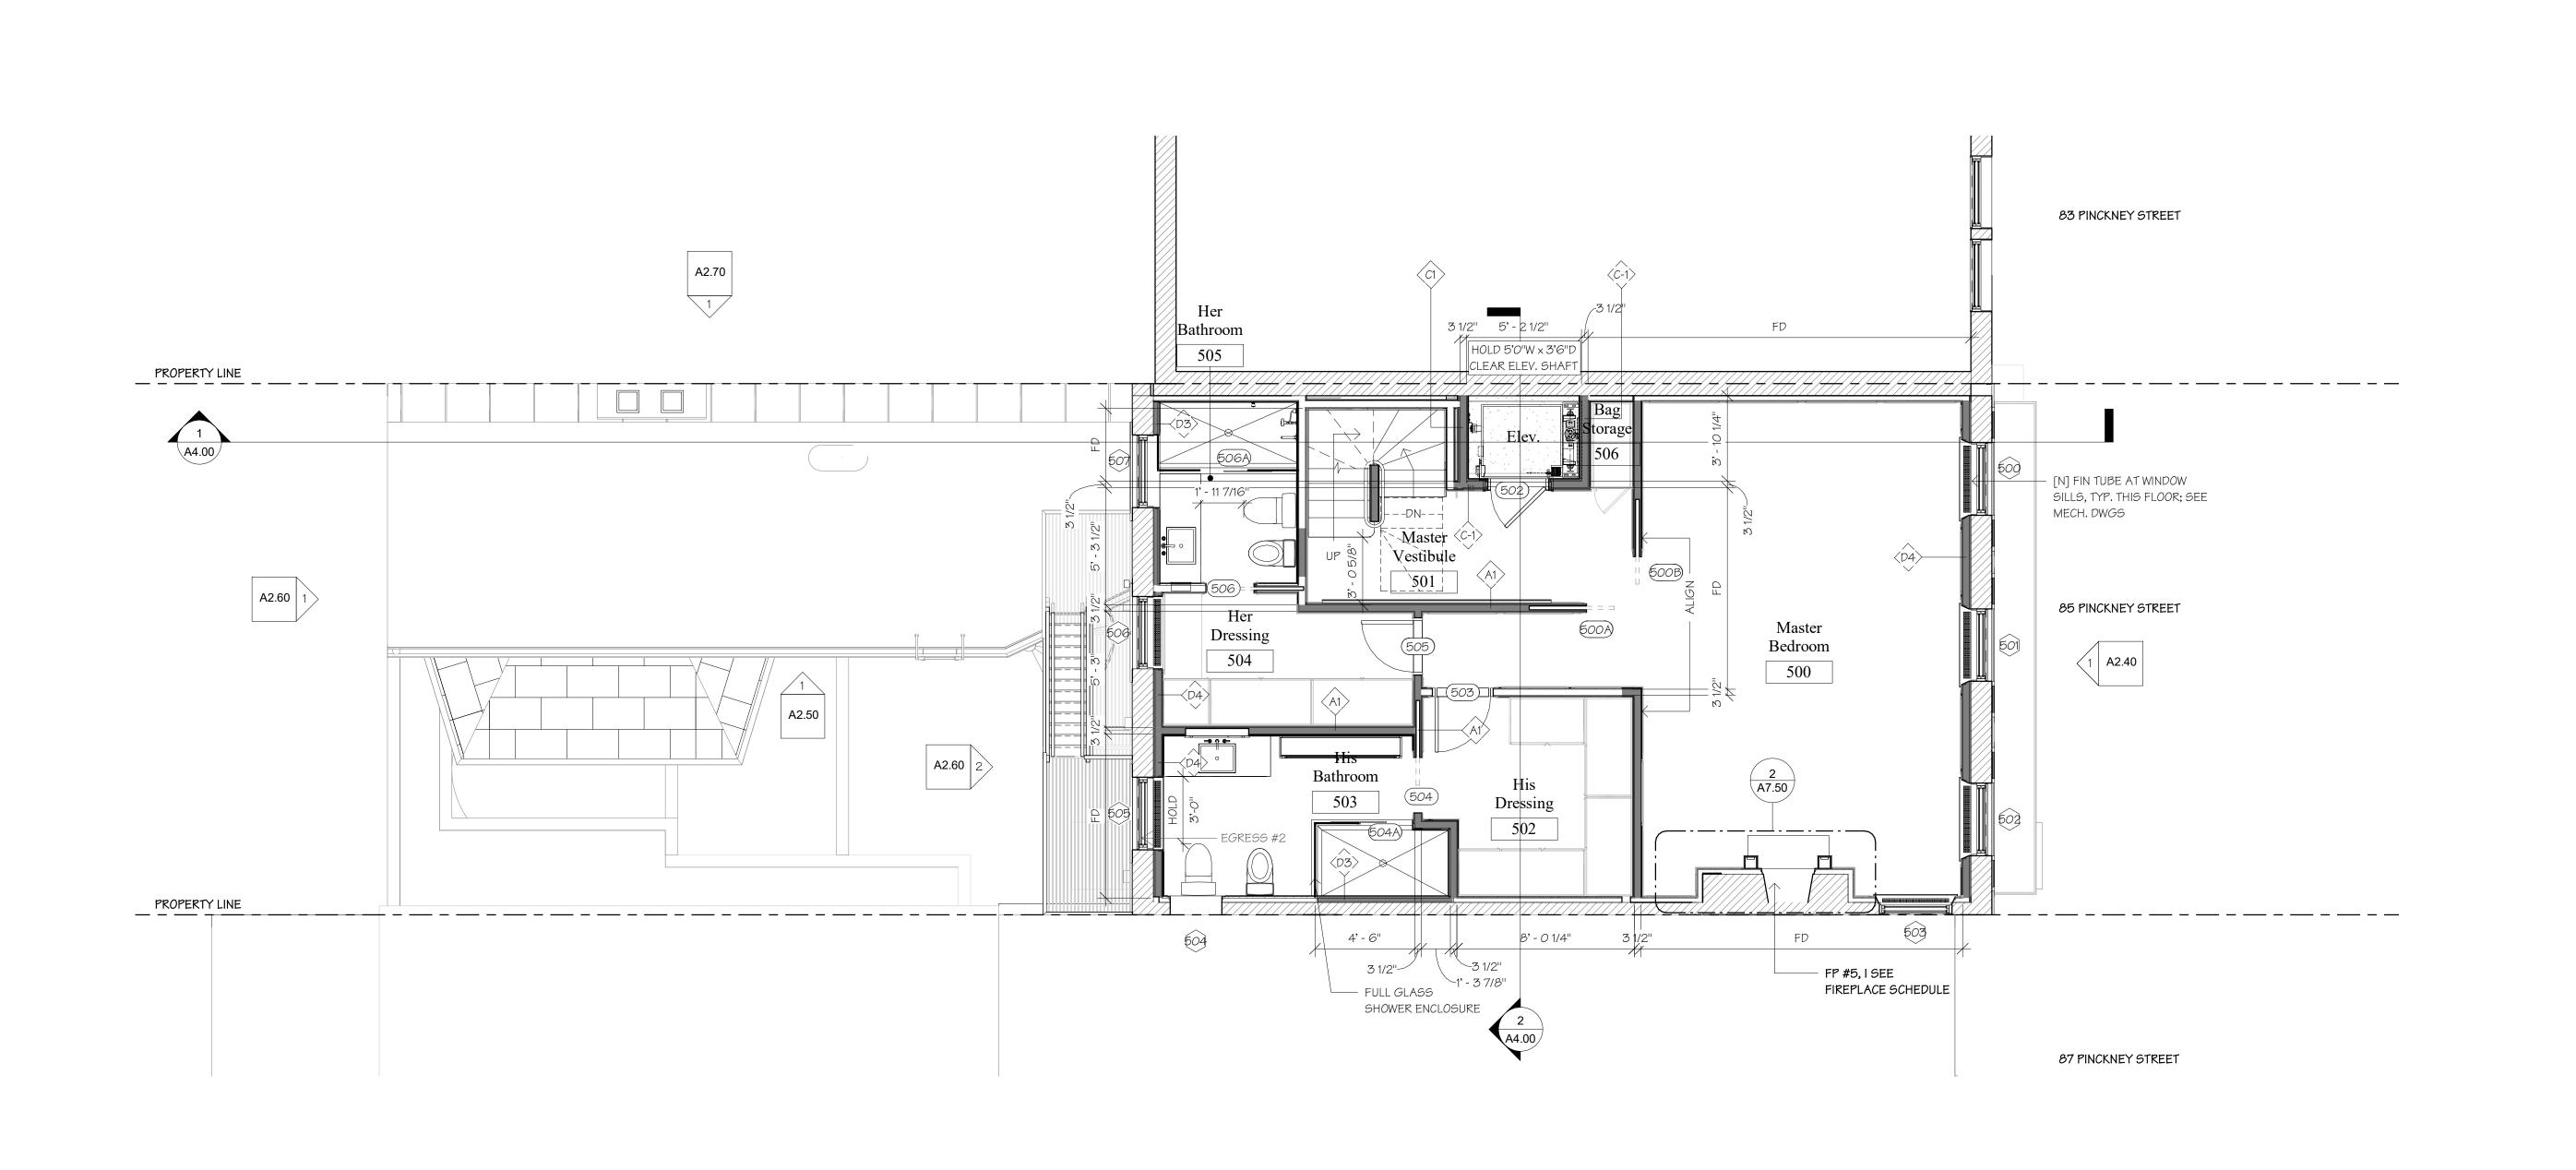
Drawing Title:

Fourth Floor

Drawn:

Checked:

Project Number:





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2. FULL BUILDING WIFI COVERAGE

4. TELEVISION DISTRIBUTION SYSTEM

3. BASIC TELEPHONE SYSTEM WITH ENTRY DOOR INTERCOM CONNECTIVITY

ALL NEW ELECTRICAL SERVICE AT BUILDING INTERIOR

ALL NEW ELECTRICAL SUB PANELS ALL NEW ELECTRICAL WIRING

ALL NEW ELECTRICAL DEVICES

ALL NEW ADDITIONAL ELECTRICAL DEVICES REQUIRED BY CODE

SMOKE/CO DETECTORS HARD WIRED WITH BATTERY BACKUP

PROVIDE JAMB SWITCHES AT ALL CLOSET DOORS, UNLESS OTHERWISE NOTED ELECTRIC RADIANT HEAT IN HIS AND HERS BATHROOMS

RELOCATE WATER METER (AND BOOSTER UNIT) TO NEW MECH ROOM, PROVIDE FOR FUTURE SP SIDE SUB METER TO BASEMENT UNIT

ALL NEW HOT AND COLD WATER SUPPLIES

ALL NEW DRAIN LINES AND DRAIN STACKS AT BUILDING INTERIOR

ALL NEW DOMESTIC WATER HEATING EQUIPMENT

ALL NEW AREA HEATING WATER HEATING EQUIPMENT ALL NEW PLUMBING FIXTURES

ALL NEW ADDITIONAL PLUMBING DEVICES REQUIRED BY CODE

ALL NEW GAS LINES AT BUILDING INTERIOR NEW WATER SOFTENER, SUMP PUMP AND PRESSURE BOOSTER PUMP

ALL NEW HEATING AND COOLING EQUIPMENT AT INTERIOR OF BUILDING

ALL NEW DUCT, INSULATE PER CODE

ALL NEW CONDENSER/HEAT PUMP AT EXTERIOR OF BUILDING ALL NEW HEATING AND COOLING EQUIPMENT PLUMBING CONNECTIONS

ALL NEW HEATING AND COOLING ELECTRICAL CONNECTIONS


NEW ELEVATOR VENTILATION NEW GAS LOG INSERTS WHERE NOTED, INSTALL NEW CONCENTRIC CHIMNEY LINERS THESE LOCATIONS SUPPLY GRILLES TO BE TITUS 301FL, RETURN GRILLES TO BE TITUS 350FL

ALL NEW SPRINKLER NFPA 13 SYSTEM

ALL NEW FIRE ALARM SYSTEM NEW DEDICATED 1 1/2" (OR 2") WATER SUPPLY LINE FROM STREET MAIN TO BUILDING

1. NEW ROPED HYDRAULIC ELEVATOR AND ASSOCIATED EQUIPMENT IN ENLARGED EXISTING SHAFT



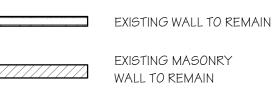











DIMENSION TO FACE OF STUD



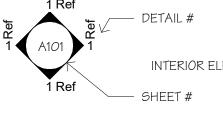




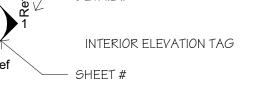



- DETAIL#

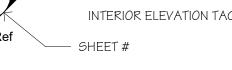




EXTERIOR ELEVATION TAG





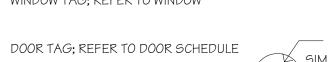



F: 617.266.29: T: 617.266.05 Project: 85 Pinckney St

MEYER & MEYER

ARCHITECTURE AND INTERIORS

85 Pinckney Street

Boston, MA

ASI-001

Issue Dates and Revisions: 10/23/2018 Permit Set Bid Set 11/01/2018 12/12/2018 50% CD Set 100% CD Set 01/11/2019 02/14/2019

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ROOF DRAIN

CENTERLINE

UNLESS NOTED OTHERWISE

ABOVE FINISHED FLOOR

GENERAL CONTRACTOR

WALL TYPE; REFER TO A4.10

FLOOR TYPE; REFER TO A4.11

VERIFY IN FIELD

FIELD DIMENSION

R.D.

A.F.F.



Checker


Drawing Title:

Fifth Floor Plan

Drawn:

Author Checked:

Project Number:

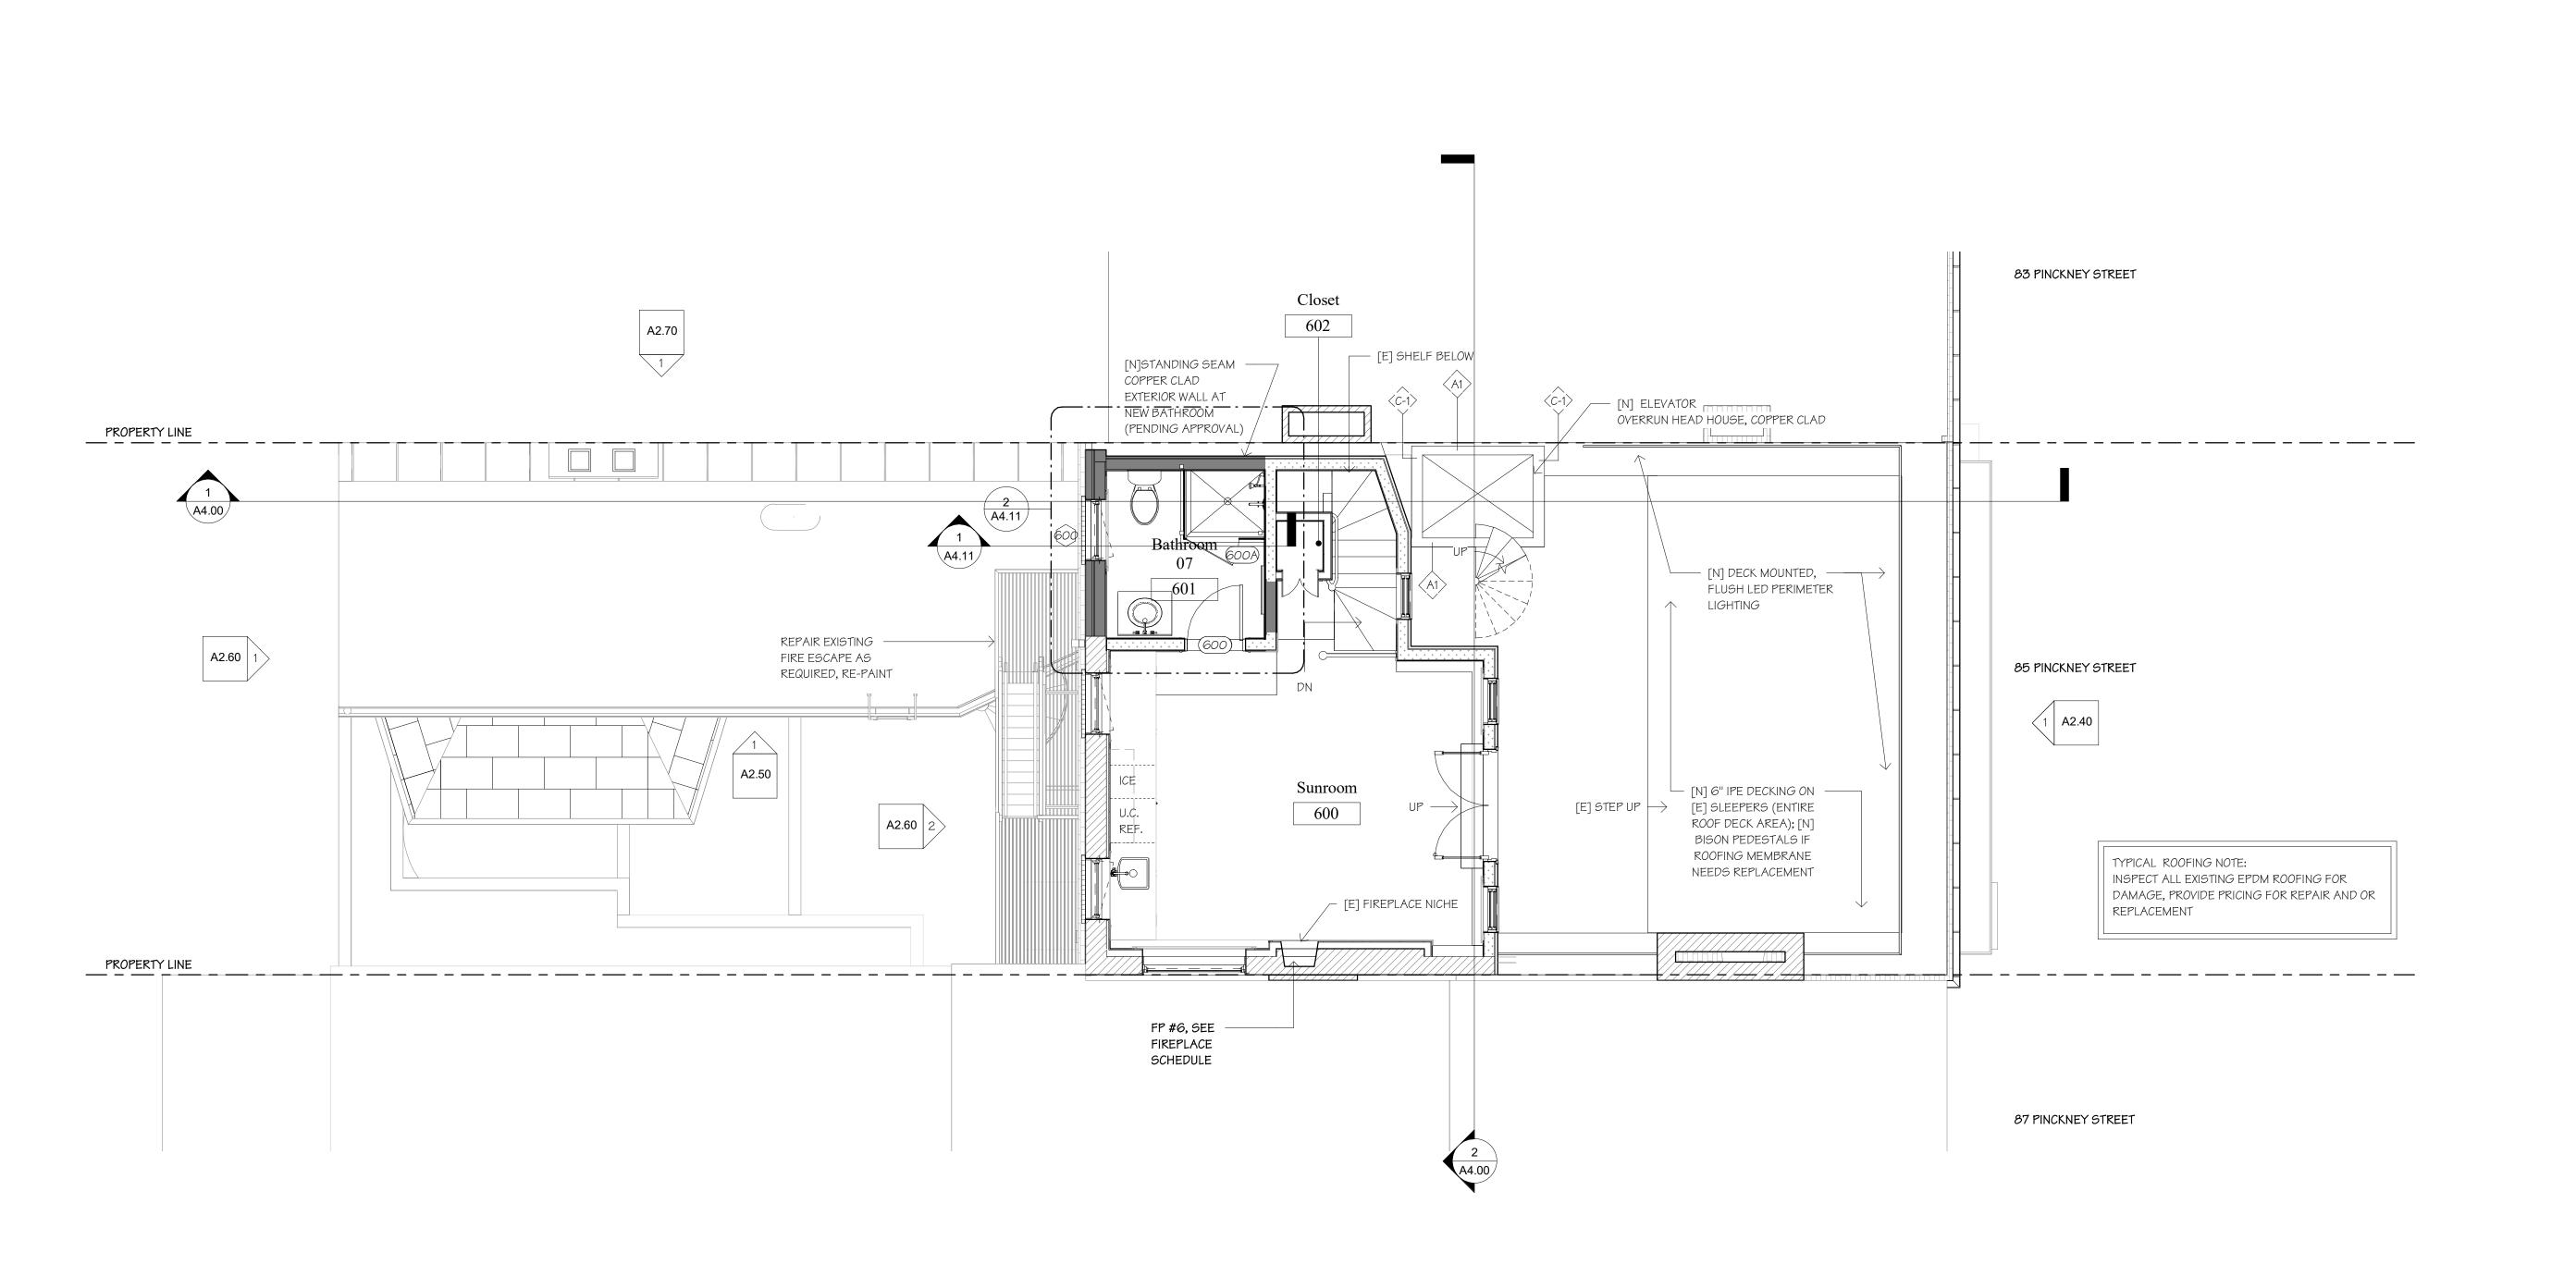



- 1. TYPICAL WALL ASSEMBLIES:
 - A. UNLESS OTHERWISE NOTED, ALL NEW AND/OR PATCHED INTERIOR WALL CONSTRUCTION SHALL BE 2" X 4" (UNLESS OTHERWISE NOTED, SEE PLAN) WOOD STUDS @ 16" O.C. WITH 1/2" GWB AND 1/8" SKIM COAT PLASTER FINISH ON BOTH SIDES OF STUDS, TYP. REFER TO FINISH SCHEDULE FOR TRIM & WALL FINISHES
- 2. G.C. SHALL BE RESPONSIBLE FOR PROVIDING WOOD BLOCKING AS REQUIRED FOR ALL ITEMS INCLUDING BUT NOT LIMITED TO CLOSET POLES, BUILT-INS, CABINETS SHELVING, BATHROOM ACCESSORIES AND DECORATIVE LIGHTING.
- ALL NEW WALL CONSTRUCTION AND/OR WALL, CEILING, AND FLOOR INFILL THAT TIES INTO EXISTING CONSTRUCTION SHALL BE FURRED OUT AS
- REQUIRED TO ALIGN WITH EXISTING ADJACENT OR ABUTTING. ALL SEAMS AND JOINTS SHALL BE FULLY CONCEALED, TYPICAL THROUGHOUT. PATCHED WOOD FLOORING SHALL BE TOOTHED INTO EXISTING ADJACENT FLOORING, TYPICAL. THROUGHOUT U.N.O.
- 5. ALL GWB AT NON SHOWER WET WALLS SHALL BE MOISTURE RESISTANT WITH 1/8" SKIM COAT PLASTER FINISH, ALL SHOWER WALLS TO HAVE CEMENTATIOUS BACKER BOARD
- SEE TYPICAL WALL TYPE SHEET AND PLANS FOR WALL INSULATION INFORMATION.
- ALL FLOORS TO HAVE 6" MINIMUM MINERAL WOOL BATT ACOUSTIC INSULATION
- INTERIOR PAINTING SHALL INCLUDE ALL PREP WORK, ONE COAT PRIMER, AND TWO COATS FINISH. WALLS AND CEILINGS SHALL BE LATEX, U.N.O.
- AT ALL STONE/TILE WORK, G.C. SHALL FULLY COORDINATE ALL JOINT AND SEAM LOCATIONS WITH ARCHITECT PRIOR TO CONSTRUCTION. ALL TILE TO
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EXISTING WOOD FLOOR FINISH TO REMAIN DURING CONSTRUCTION. CONTRACTOR IS FULLY RESPONSIBLE FOR REPAIRING ANY DAMAGES, NICKS,

- SCRATCHES. 12. REFER TO ALL DRAWINGS, SCHEDULES, ALLOWANCES, DETAILS, AND ALL NOTES FOR SCOPE OF WORK. ANY ALLOWANCES PROVIDED ARE FOR
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- UNLESS OTHERWISE NOTED, DOOR JAMBS SHALL BE LOCATED 5" FROM ADJACENT WALL AND DOOR JAMB (FRAME TO FRAME) LEVEL ALL SUBFLOORS
- REPAIR AND REPAINT EXISTING INTERIOR SHUTTERS
- ALL FURRED EXTERIOR (AND PARTY) WALL CAVITIES TO BE FILLED WITH OPEN CELL INSULATION; SEE WALL TYPES.
- 18. PROVIDE ALL NEW WINDOW HARDWARE; SEE HARDWARE SCHEDULE

TYPICAL PLAN NOTES ELECTRICAL

RELOCATE THREE METERS TO NEW MECH ROOM, MAINTAIN ONE METER FOR MAIN HOUSE, ONE METER FOR BASEMENT UNIT AND ONE METER FOR BUILDING

COMMON AREAS

<u>AV</u>-PER AV CONSULTANT

5. MOTORIZED SHADES

1. LIGHTING CONTROL SYSTEM

2. FULL BUILDING WIFI COVERAGE

4. TELEVISION DISTRIBUTION SYSTEM

3. BASIC TELEPHONE SYSTEM WITH ENTRY DOOR INTERCOM CONNECTIVITY


- ALL NEW ELECTRICAL SERVICE AT BUILDING INTERIOR
- ALL NEW ELECTRICAL SUB PANELS
- ALL NEW ELECTRICAL WIRING
- ALL NEW ELECTRICAL DEVICES ALL NEW ADDITIONAL ELECTRICAL DEVICES REQUIRED BY CODE
- SMOKE/CO DETECTORS HARD WIRED WITH BATTERY BACKUP
- PROVIDE JAMB SWITCHES AT ALL CLOSET DOORS, UNLESS OTHERWISE NOTED

ELECTRIC RADIANT HEAT IN HIS AND HERS BATHROOMS

RELOCATE WATER METER (AND BOOSTER UNIT) TO NEW MECH ROOM, PROVIDE FOR FUTURE SP SIDE SUB METER TO BASEMENT UNIT

- ALL NEW HOT AND COLD WATER SUPPLIES ALL NEW DRAIN LINES AND DRAIN STACKS AT BUILDING INTERIOR
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- ALL NEW PLUMBING FIXTURES ALL NEW ADDITIONAL PLUMBING DEVICES REQUIRED BY CODE
- ALL NEW GAS LINES AT BUILDING INTERIOR
- NEW WATER SOFTENER, SUMP PUMP AND PRESSURE BOOSTER PUMP
- ALL NEW HEATING AND COOLING EQUIPMENT AT INTERIOR OF BUILDING ALL NEW DUCT, INSULATE PER CODE
- ALL NEW CONDENSER/HEAT PUMP AT EXTERIOR OF BUILDING ALL NEW HEATING AND COOLING EQUIPMENT PLUMBING CONNECTIONS
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PLAN LEGEND



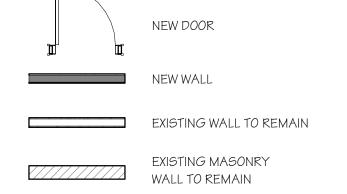










DOOR TAG; REFER TO DOOR SCHEDULE DIMENSION TO FACE OF STUD

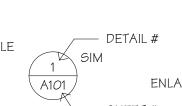

- DETAIL# R.D. ROOF DRAIN



FIELD DIMENSION WALL TYPE; REFER TO A4.10 FLOOR TYPE; REFER TO A4.11

- DETAIL# INTERIOR ELEVATION TAG

ENLARGED PLAN KEY

F: 617.266.29: T: 617.266.05

MEYER & MEYER

ARCHITECTURE AND INTERIORS

85 Pinckney St

85 Pinckney Street Boston, MA

Issue Dates and Revisions:

10/23/2018 11/01/2018 Bid Set 12/12/2018 50% CD Set 100% CD Set 01/11/2019 02/14/2019 ASI-001

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Author

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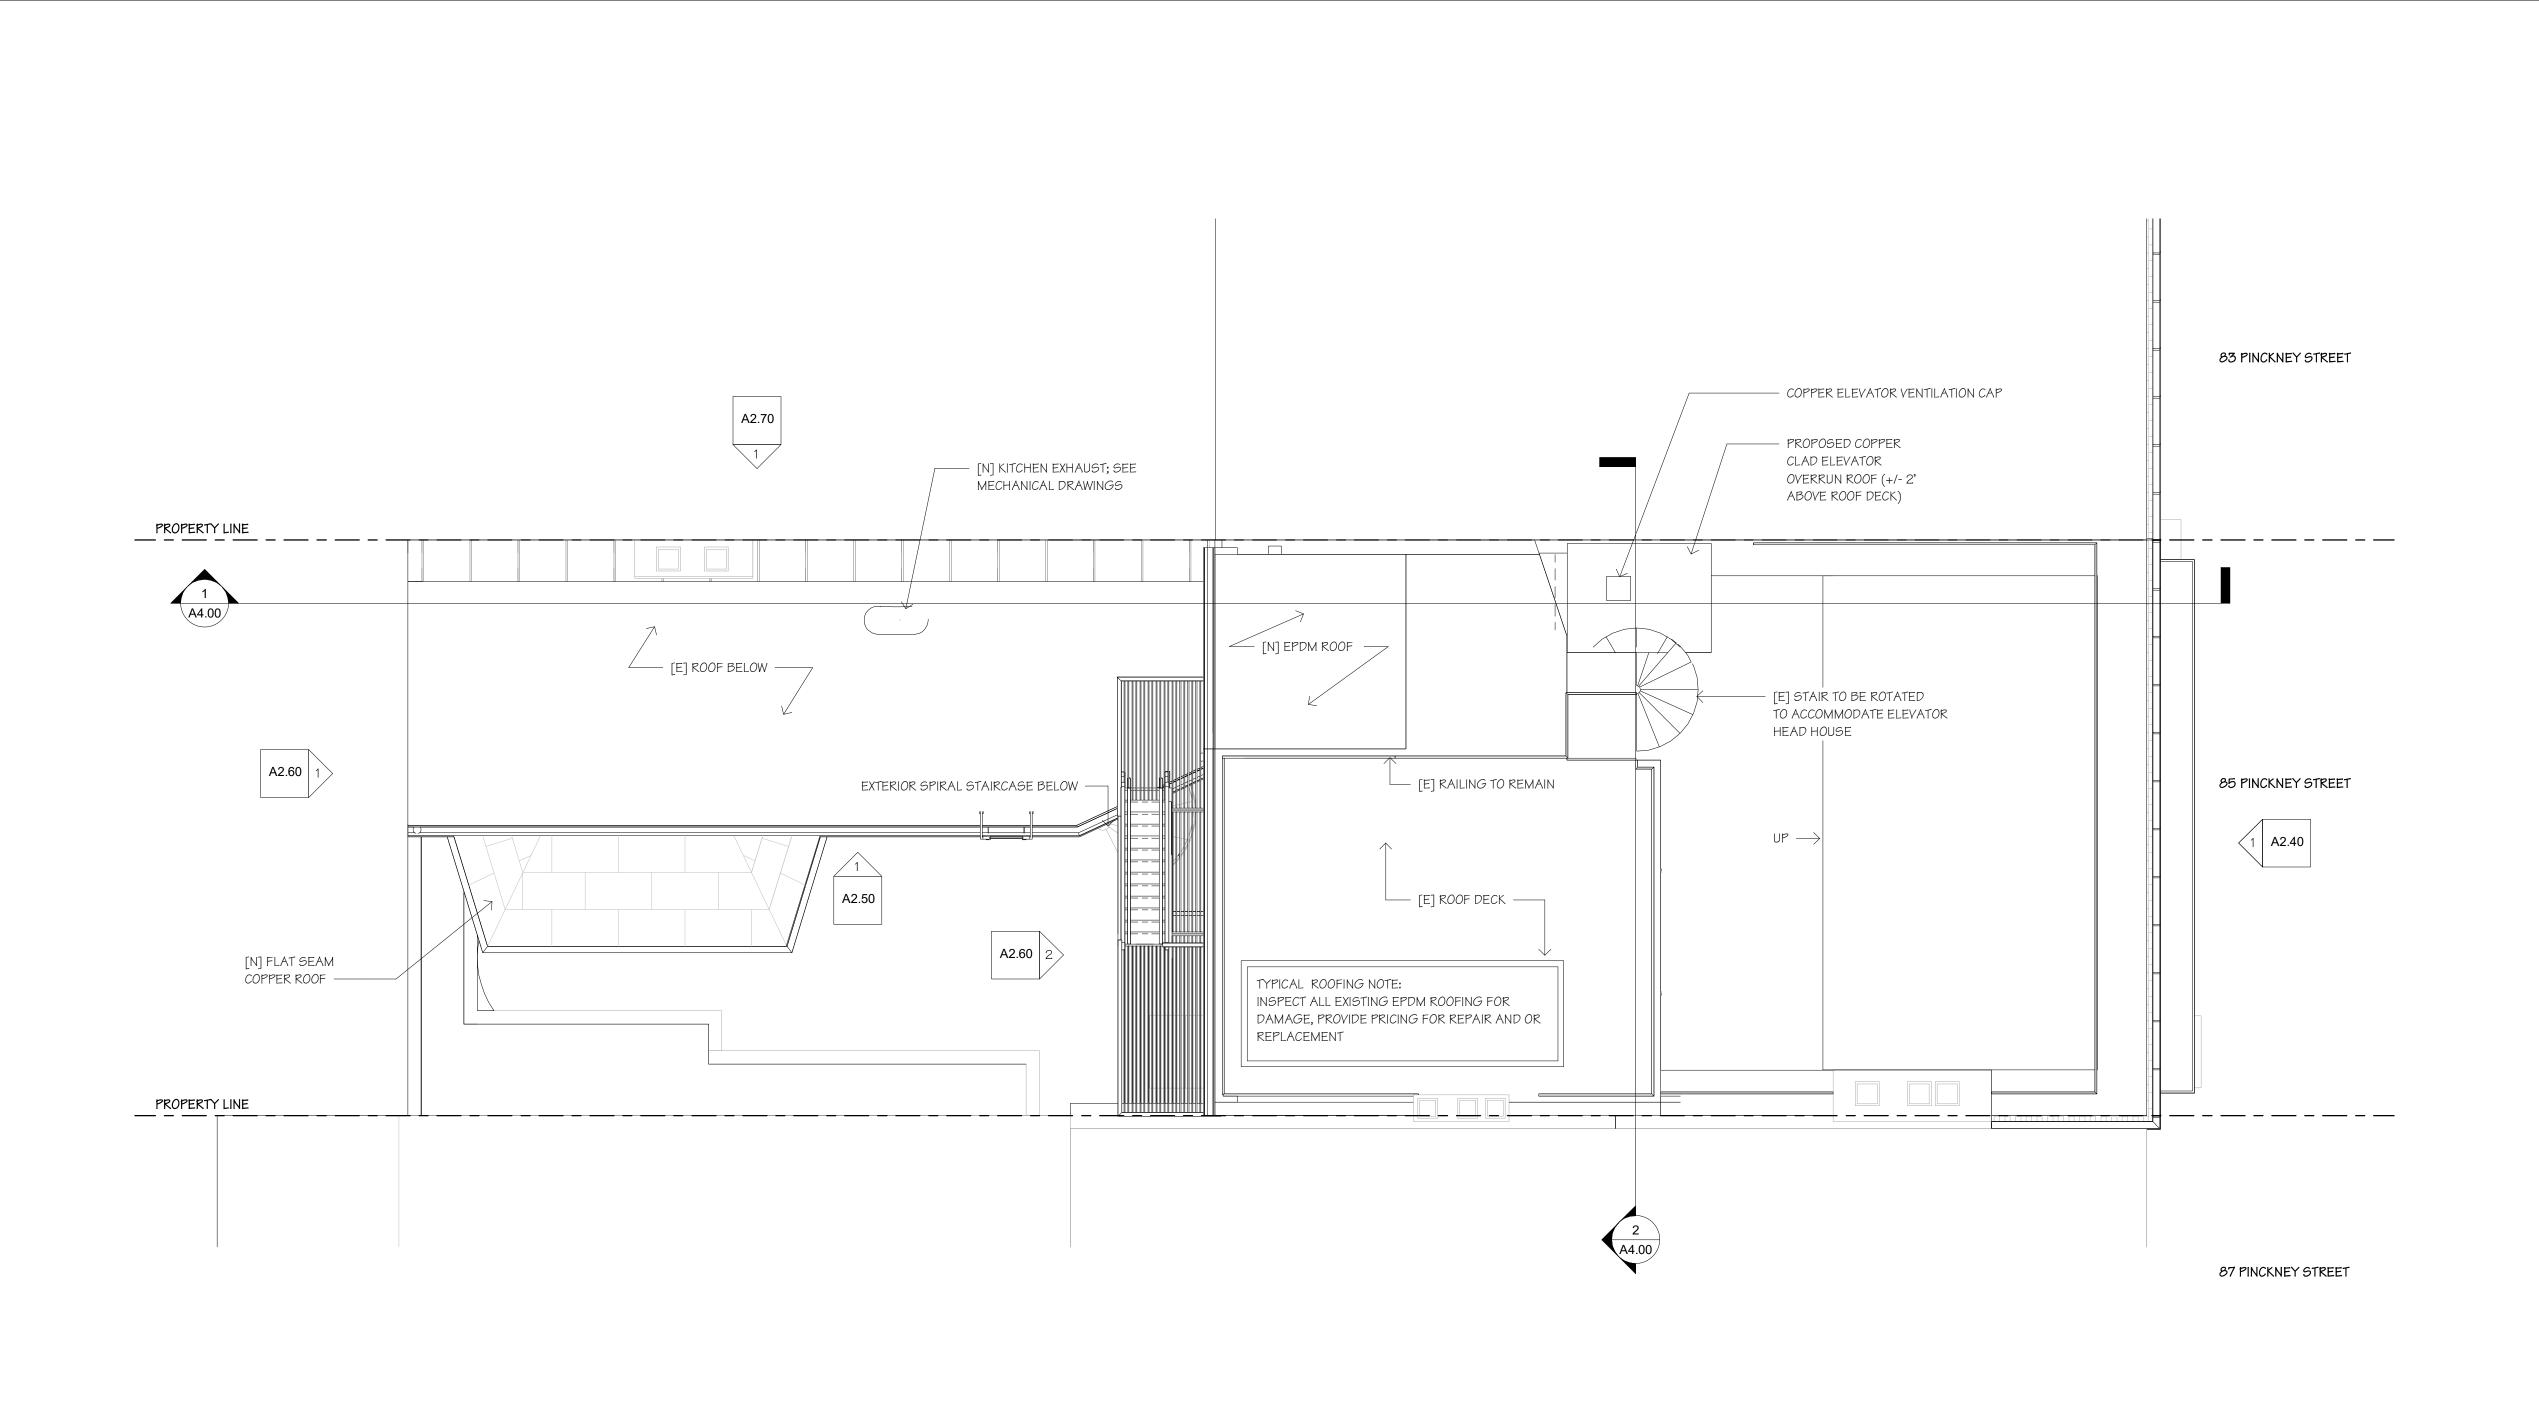
Drawing Title:

Sixth Floor Plan

Drawn:

Checked:

Project Number:





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- REPAIR AND REPAINT EXISTING INTERIOR SHUTTERS
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- PROVIDE ALL NEW WINDOW HARDWARE; SEE HARDWARE SCHEDULE

TYPICAL PLAN NOTES

RELOCATE THREE METERS TO NEW MECH ROOM, MAINTAIN ONE METER FOR MAIN HOUSE, ONE METER FOR BASEMENT UNIT AND ONE METER FOR BUILDING COMMON AREAS

<u>AV</u>-PER AV CONSULTANT

5. MOTORIZED SHADES

1. LIGHTING CONTROL SYSTEM

2. FULL BUILDING WIFI COVERAGE

4. TELEVISION DISTRIBUTION SYSTEM


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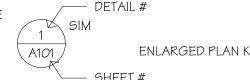









DIMENSION TO FACE OF STUD

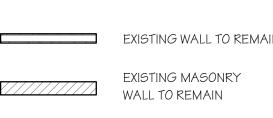

ROOF DRAIN U.N.O. UNLESS NOTED OTHERWISE CENTERLINE

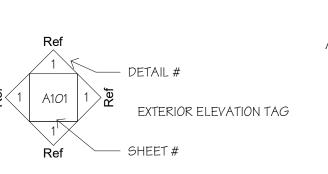

- DETAIL#

VERIFY IN FIELD FIELD DIMENSION WALL TYPE; REFER TO A4.10

ABOVE FINISHED FLOOR

GENERAL CONTRACTOR

FLOOR TYPE; REFER TO A4.11



ENLARGED PLAN KEY



MEYER & MEYER

ARCHITECTURE AND INTERIORS

85 Pinckney St

85 Pinckney Street Boston, MA

Issue Dates and Revisions:

10/23/2018 11/01/2018 Bid Set 12/12/2018 50% CD Set 100% CD Set 01/11/2019

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Author

Checker

Drawing Title: Roof Plan

Drawn:

Checked:

Project Number:



MEYER & MEYER

ARCHITECTURE AND
INTERIORS

F: 617.266.295.
T: 617.266.055

396 Commonwealth Avenu
Boston, Massachusetts 0221

Project:

85 Pinckney St

85 Pinckney Street Boston, MA

Issue Dates and Revisions:

Permit Set 10/23/2018
Bid Set 11/01/2018
50% CD Set 12/12/2018
100% CD Set 01/11/2019

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Registration:



Author

Checker

85740

Drawing Title:

Existing Building

Elevations

Drawn:


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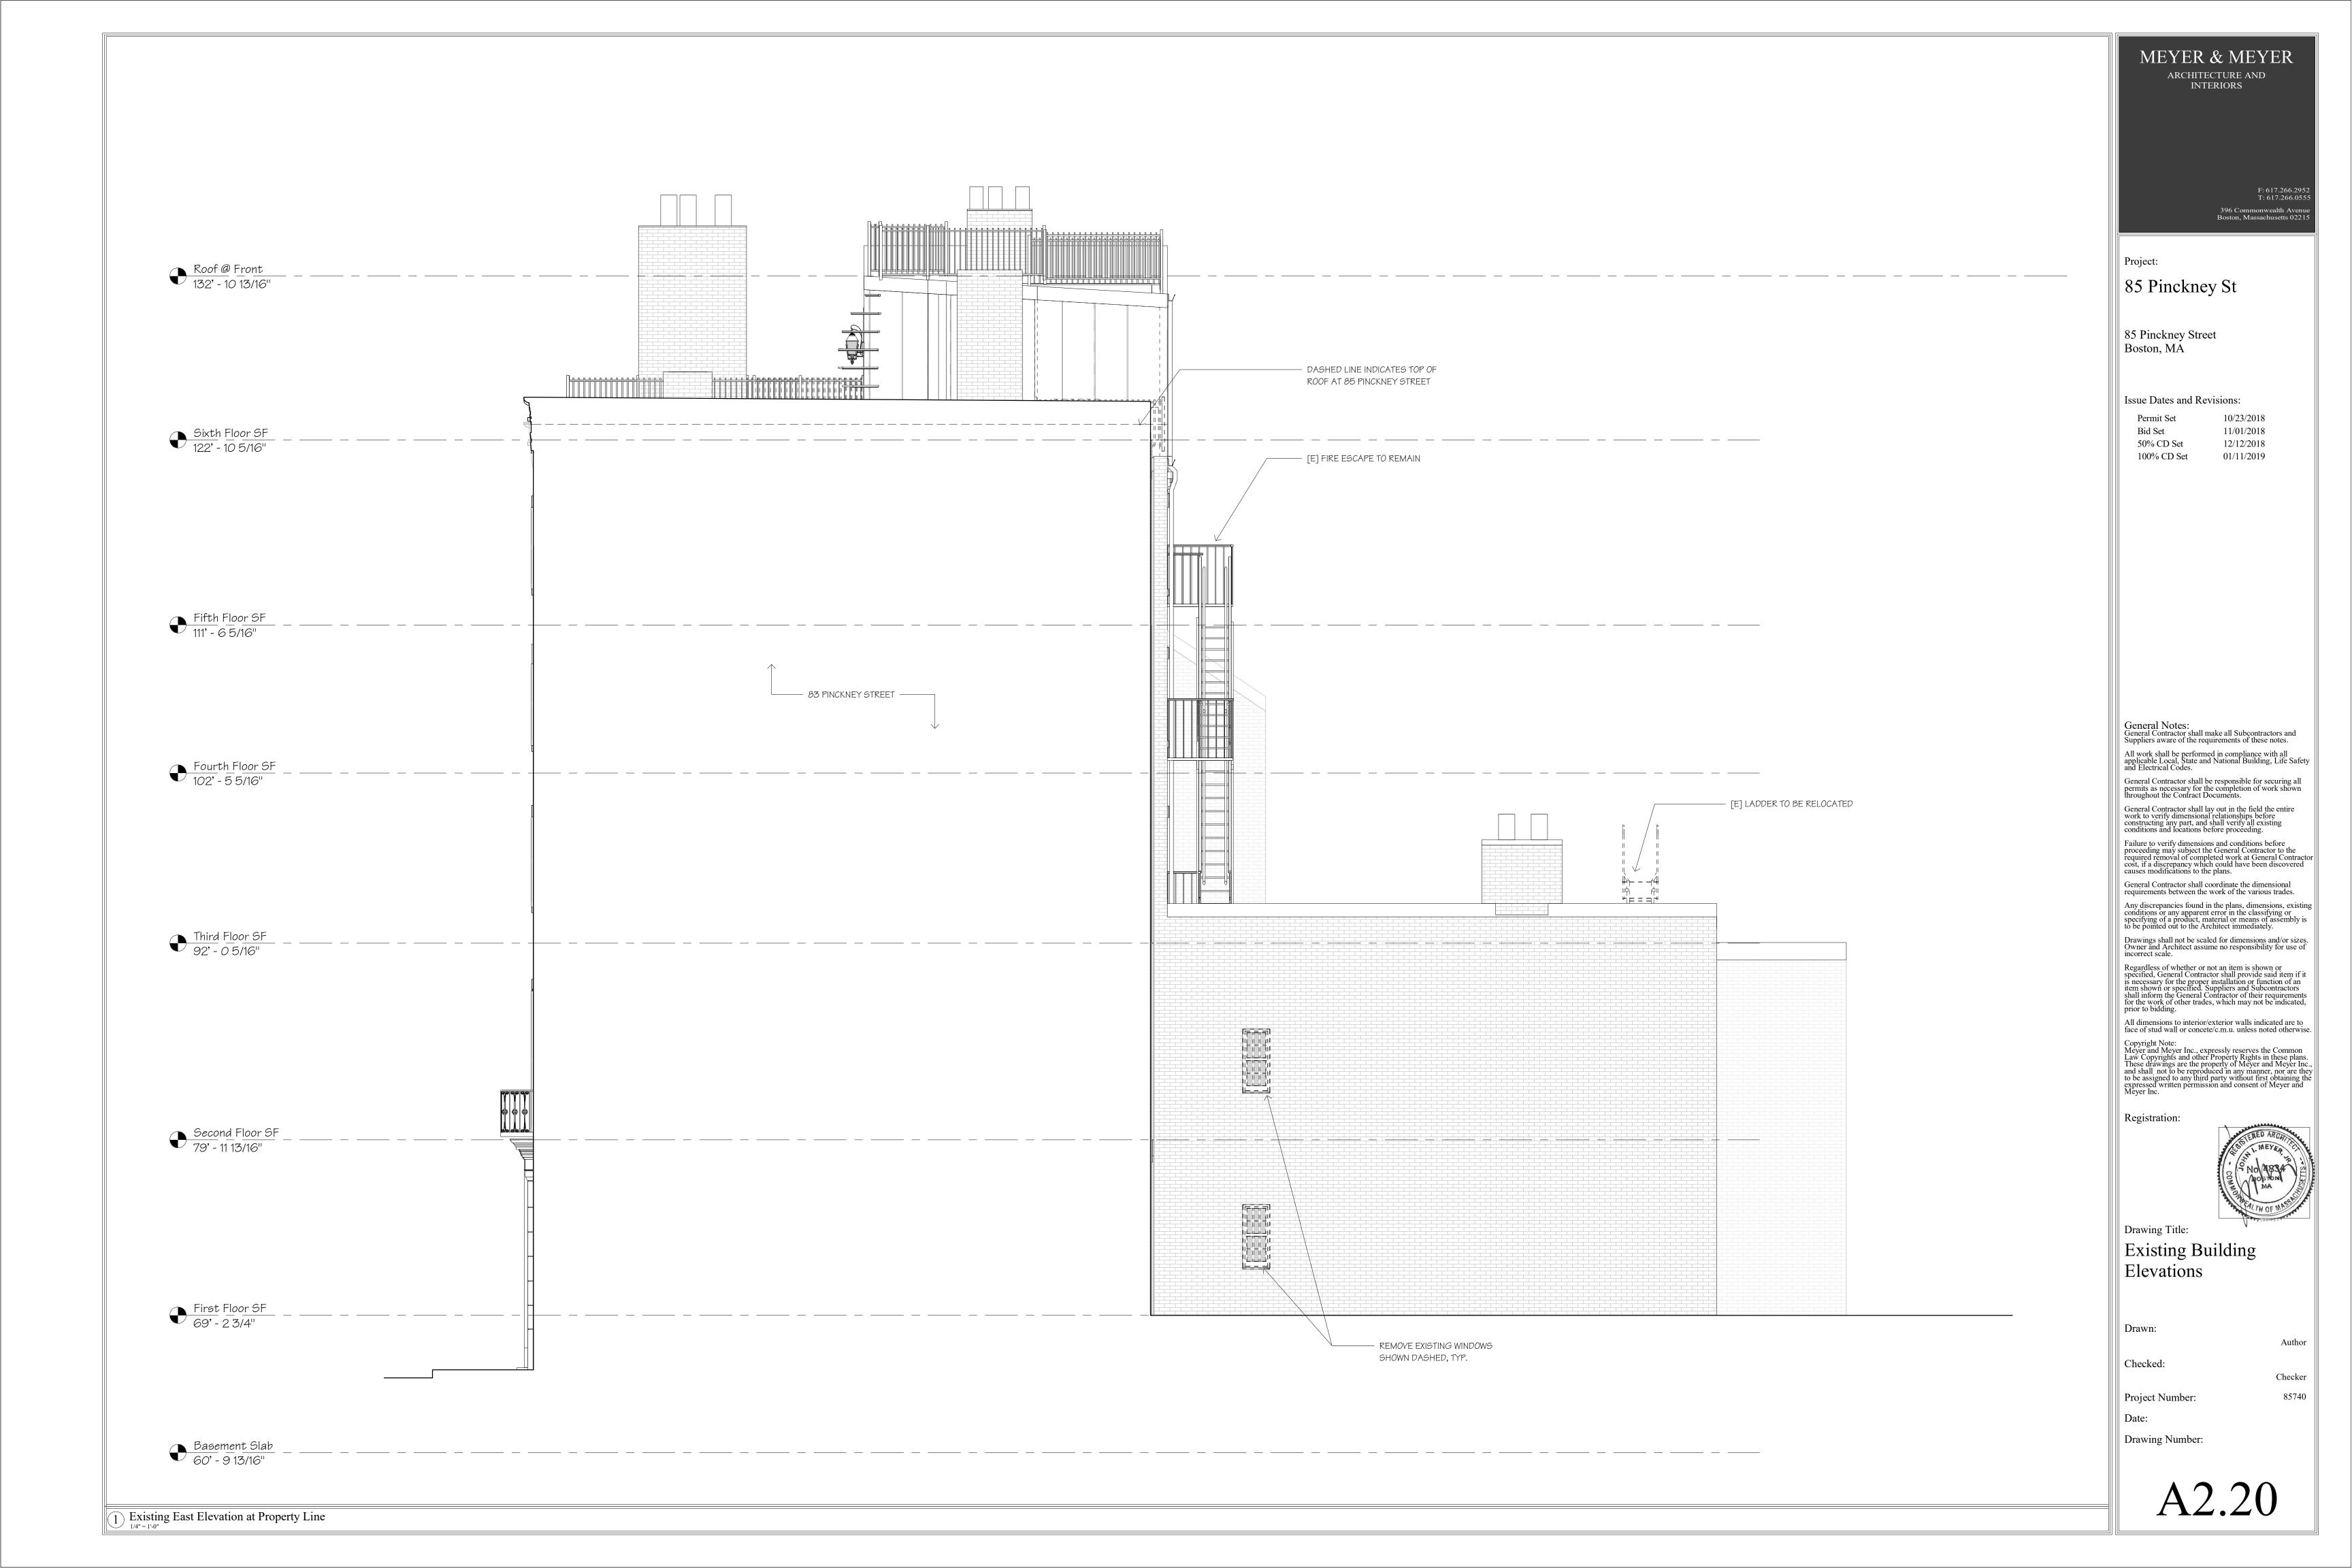
Project Number:

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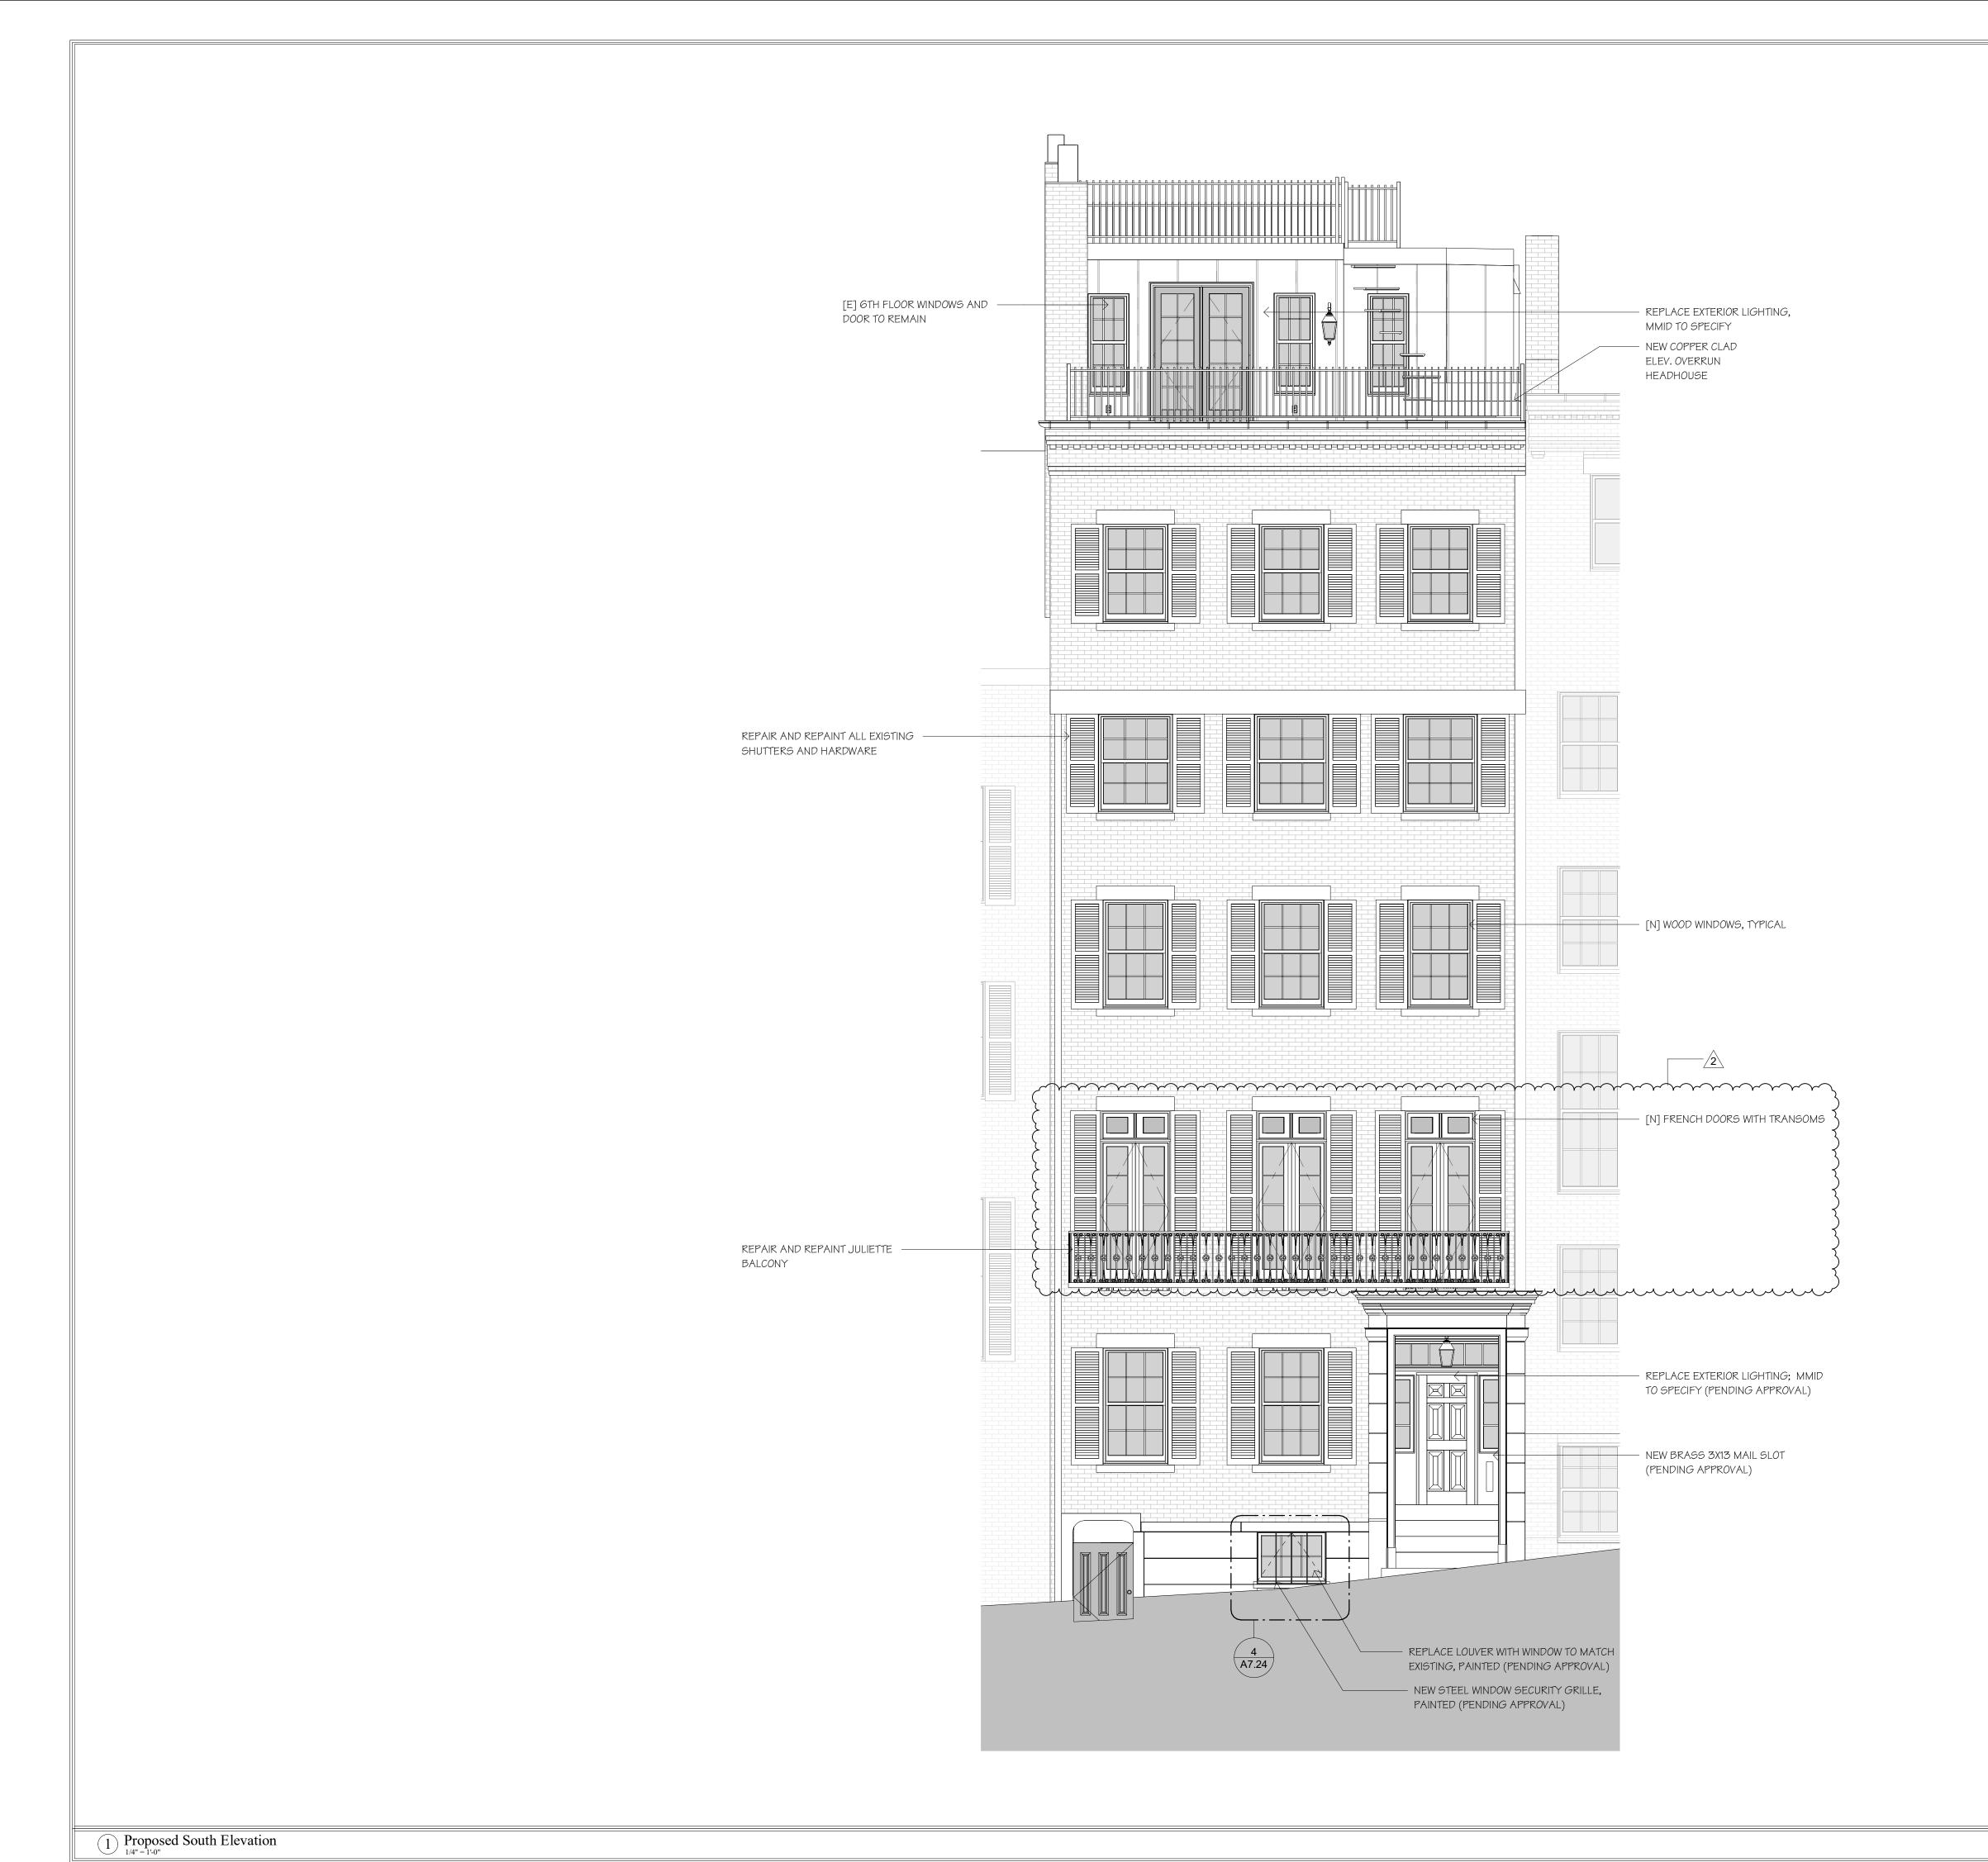
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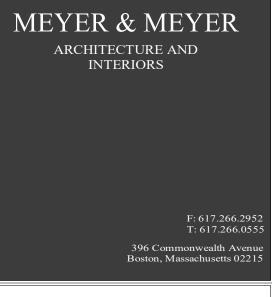
42.00







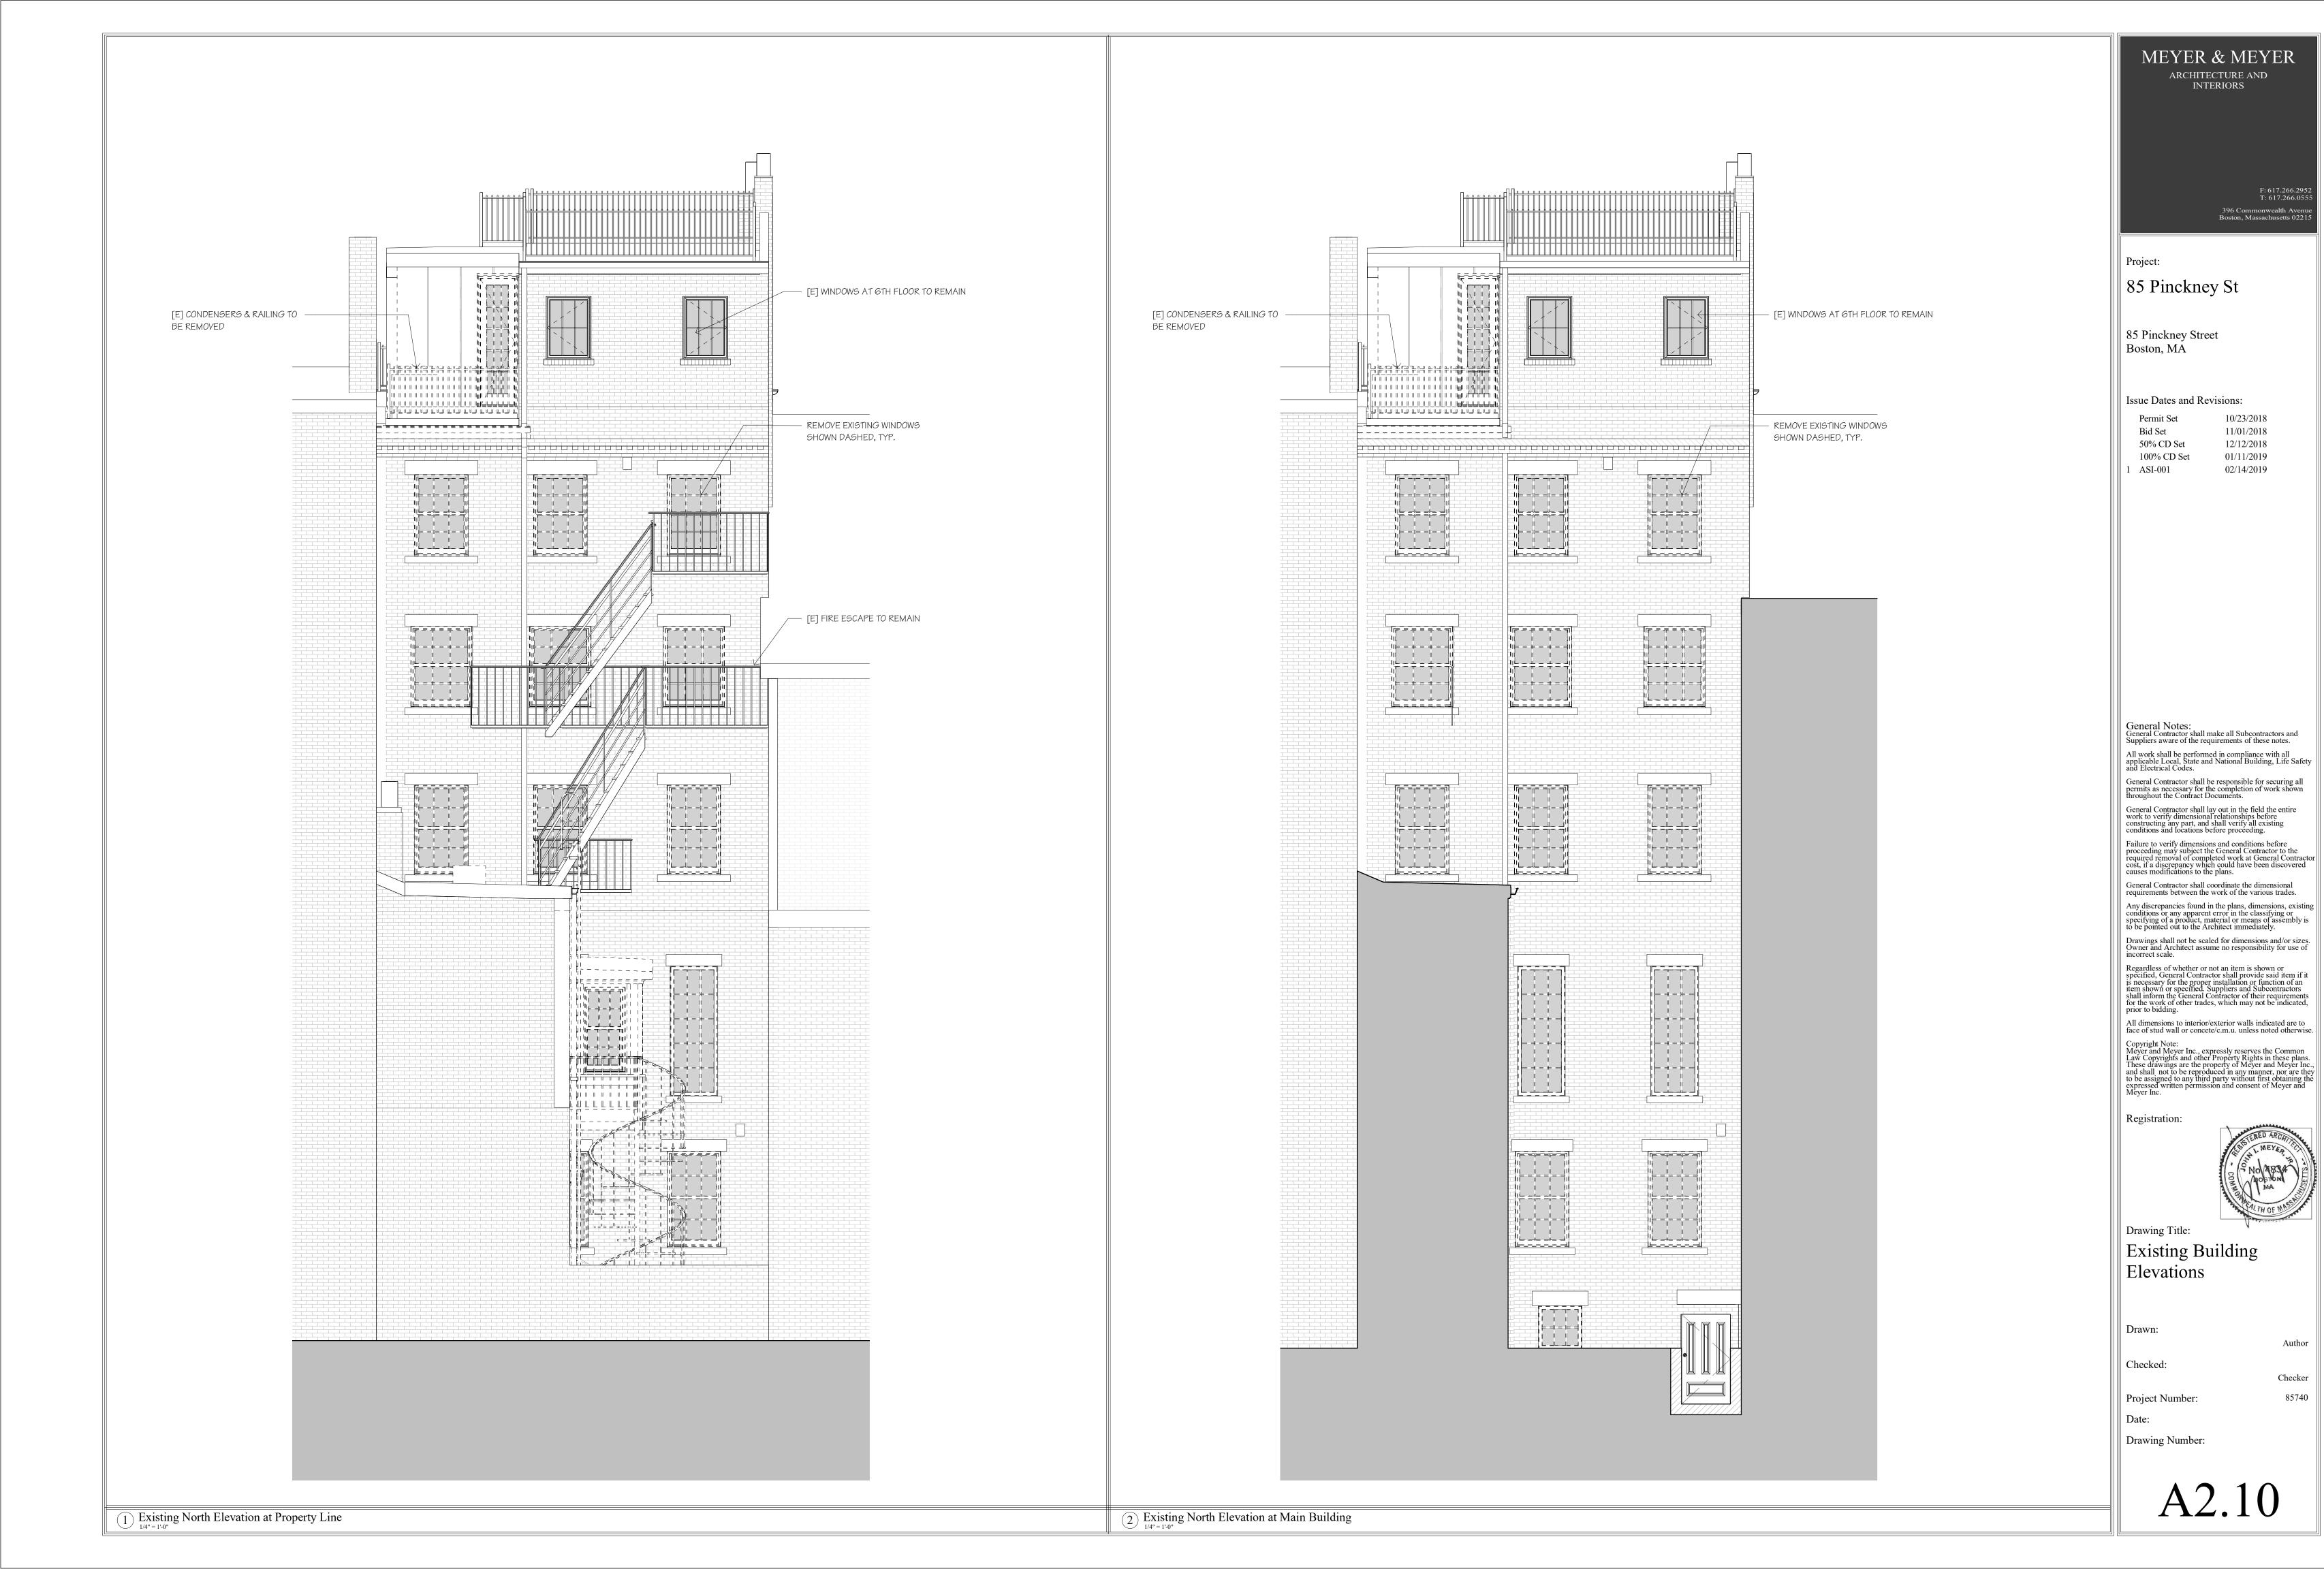



Project:

85 Pinckney St

85 Pinckney Street Boston, MA

Issue Dates and Revisions:

11/01/2018 Bid Set 50% CD Set 12/12/2018 01/11/2019 100% CD Set 2 ASI-002 TBD

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Author

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85740

Drawing Title:

Proposed Building Elevations

Drawn:

Checked:

Project Number:

Date:

