7 CHESTNUT

BOSTON, MA 02108

APRIL 20, 2022 ISSUED FOR CONSTRUCTION



ABOVE FINISHED FLOOR ACT ACOUSTICAL CEILING TILE ADA AMERICANS W/ DISABILITIES ACT APPROX. APPROXIMATE ARCH. ARCHITECTURAL **AUDIO VISUAL** BLDG. BUILDING BLKG. BLOCKING B.O. BOTTOM OF CAB. CABINET C.H. CEILING HEIGHT CLR. CLEAR CENTERLINE COL. COLUMN CONT. CONTINUOUS CMU CONCRETE MASONRY UNIT CONTROL JOINT DETAIL DIAMETER DIMENSION DOWN

C.J. DIA. DWG. DRAWING existing ELEVATION ELEC. ELECTRICAL EQ EQUAL FD. FLOOR DRAIN F.O. FACE OF F.O.C. FACE OF CONCRETE F.O.F. FACE OF FINISH

GFIC GROUND FAULT INTERCEPTOR CIRCUIT GSM. GALVANIZED SHEET METAL GWB GYPSUM WALL BOARD

H OR HVAC HEATING, VENTILATING, AND AIR CONDITIONING H.B. HOSE BIB HOLLOW METAL MAXIMUM MAX. M.O. MASONRY OPENING

MECH. MECHANICAL MEP MECHANICAL ELECTRICAL PLUMBING MIN. MINIMUM MISC. MISCELLANEOUS

MTL. METAL N.I.C. NOT IN CONTRACT NO. NUMBER N.T.S. NOT TO SCALE OVER O.C. ON CENTER O.D. OUTSIDE DIAMETER OPNG. OPENING OPP. **OPPOSITE** P.G. PAINT GRADE PLYWD. PLYWOOD PTD. PAINTED ROOF DRAIN REQ'D. REQUIRED R.O. ROUGH OPENING


SCHED. SCHEDULE S.G. STAIN GRADE SIMILAR S.L.D. SEE LANDSCAPE DRAWINGS SQ. SPEC. SPECIFICATION S.S.D. SEE STRUCTURAL DRAWINGS SSTL. STAINLESS STEEL STEEL STL.


STOR. STORAGE STRUCT. STRUCTURAL SYM. SYMMETRICAL **TEMPERED** T&G TONGUE AND GROOVE THK. T.O. TOP OF TUBULAR STEEL T.S. TYP. TYPICAL

U.O.N UNLESS OTHERWISE NOTED V.I.F. VERIFY IN FIELD WITH W/O WITHOUT

WD. WPM. WATERPROOFING MEMBRANE




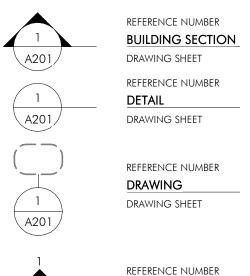

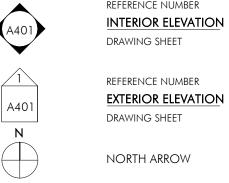

WINDOW TAG DOOR TAG WALL TYPE TAG APPLIANCE TAG **REVISION TAG**

CENTER LINE

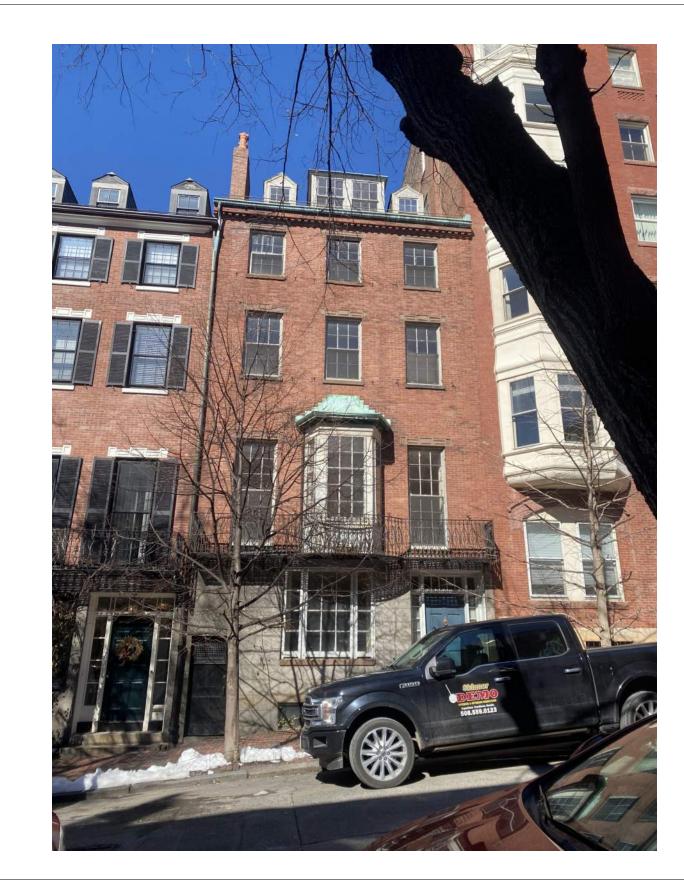

VICINITY MAP



A. USE GROUP:

R-3 (RESIDENTIAL, ONE DWELLING UNIT)

B. CONSTRUCTION CLASSIFICATION:

TYPE 3-B CONSTRUCTION

C. FULLY SPRINKLERED

RESIDENTIAL

PROJECT DATA

LEVEL	COMMON	RESIDENTIAL
GARDEN	0	913
FIRST	0	1160
SECOND	0	1174
THIRD	0	1165
FOURTH	0	1045
FIFTH	0	903
TOTAL GSF =	0 GSF	6360 GSF

COMMON AREA	0 SF
UNIT 1	1,849 SF
TOTAL	6,360 GSF


ZONING REVIEW BOSTON PROPER; H-2-65 ZONE


	ALLOWABLE	EXISTING	PROPOSED
LOT SIZE	NONE	1,665 S.F.	NO CHANGE
LOT WIDTH	NONE	23' - 8"	no change
F.A.R. (2.0)	3,330 S.F. (2.0)	5,447 S.F. (4.68)	6,359 (5.46)
BUILDING HEIGHT	65'-0"	± 58'-0"	62'-8"
FRONT YARD	20'-0"	± 3'-6"	no change
SIDE YARD	0'-0"	0'-0"	NO CHANGE
REAR YARD	30'-0"	± 24'-8"	NO CHANGE


SHEET LIST


NUMBER	NAME
A000	COVER
A001	CODE REVIEW
A002	BUILDING INFORMATION
A010	EXISTING PLANS
A011	EXISTING PLANS
D101	DEMOLITION PLANS
D102	DEMOLITION PLANS
A101	CONSTRUCTION PLANS
A102	CONSTRUCTION PLANS
A103	CONSTRUCTION PLANS
A201	BUILDING ELEVATIONS
A501	INTERIOR DETAILS


EXTERIOR DETAILS

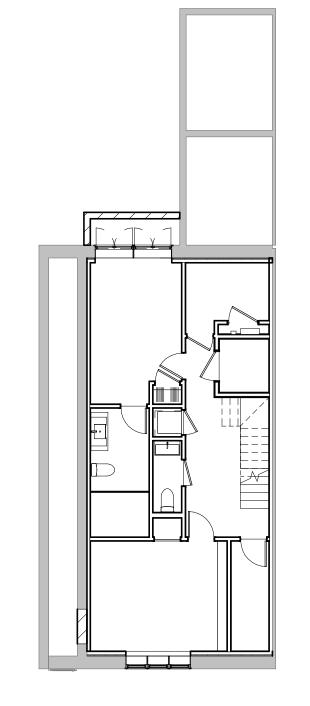


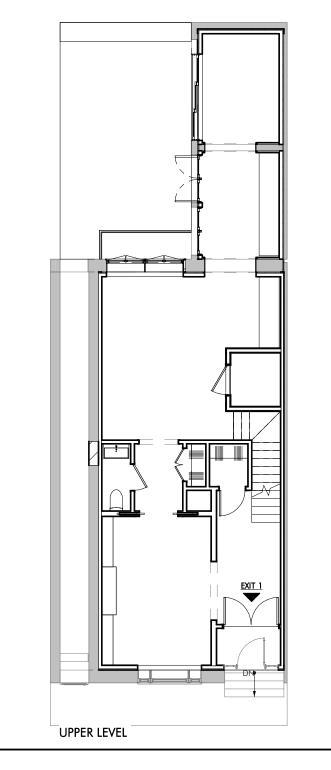


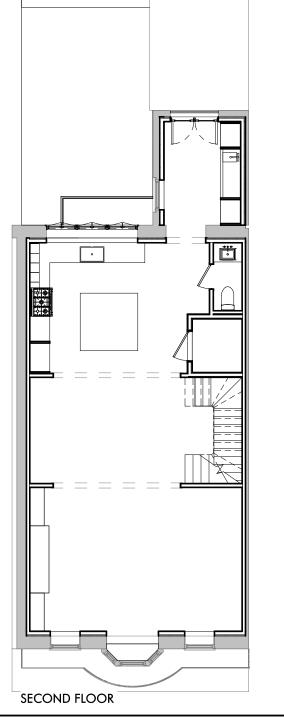

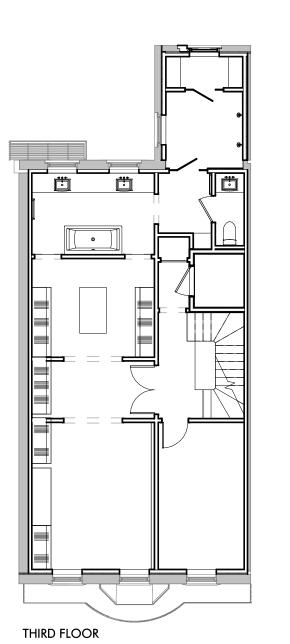

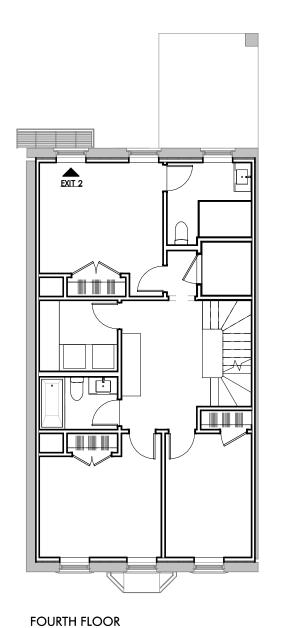

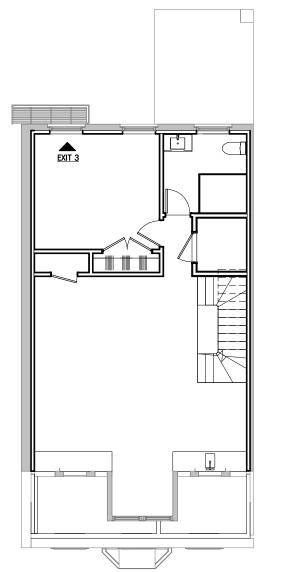

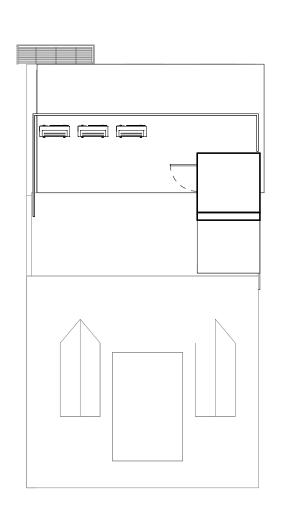

DRAWING NUMBER

DRAWING INFORMATION

PROJECT #: 22010

DRAWING TITLE

COVER

SCALE: As indicated

ISSUED FOR CONSTRUCTION

APRIL 20, 2022

BOSTON, MA 02118
O: 617.766.8330
www.embarcdesign.com

92 HIGH STREET, SUITE 22 MEDFORD, MA 02155

CONSULTANTS

7 CHESTNUT STREET LLC

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LOWER LEVEL

FIFTH FLOOR

ROOF LEVEL

Building Overview: The building is an existing five-story residential building. No Change of us or occupancy classification. Proposed work to include (1) proposed dwelling unit, mechanical headhouse, exterior restoration.

Only the exterior brick walls and roofs will be retained. The existing wood interior framing and all other infrastructure is to be removed in its entirety.

The building is to be fully sprinklered per NFPA 13.

This report is based on the IBC 2015, the IEBC 2015, MA amendments; collectively the 9th Edition of 780 CMR. Using the Work Area Method, this is a Level 3 project.

APPLICABLE CODES

Code Type Applicable Code

(Model Code Basis). 780 CMR: Massachusetts Building Code (9th Edition) Building (2015 International Building Code, amended) (2015 International Existing Building Code, amended) 2015 International Energy Conservation Code, amended Fire 527 CMR: Massachusetts Fire Prevention Regulations

(2012 NFPA-1, amended) NFPA 10 for fire extinguisher placement

NFPA 13 for fire protection systems 521 CMR: Massachusetts Architectural Access Board Regulations (2006) Accessibility ADA: Americans With Disabilities Act (ADAAG 2010)

527 CMR 12.00: Massachusetts Electrical Code Electrical (2017 National Electrical Code, amended) Mechanical 2015 International Mechanical Code 248 CMR 10.00: Massachusetts Plumbing Code Plumbing 105 CMR 410: Masssachusetts State Sanitary Code .Şanitary

Existing Building Overview

Group R-3 (one- or two- family residential), 1 unit Existing Occupancy: Proposed Occupancy: Group R-3 (one- or two- family residential), 1 unit 5 stories; 62'-8"; 6,359 ft² Height and Area: Minimum Construction Type: Type IIIB (Fully Sprinklered)

<u>Project Data</u>

 LEVEL	СОММОМ	RESIDENTIAL
GARDEN	0	913
FIRST	0	1160
 second	0	1174
 THIRD	0	1165
FOURTH	0	1045
· · · FIFTH	0 · ·	903
TOTAL GSF =	0 GSF	6359 GSF

Work Area Compliance Method

The premise behind the three levels of work is, besides requiring that all new equipment and systems meet the code for new construction, that additional building improvements are required above and beyond the scope of work otherwise proposed.

Alterations -- Level 1: Level 1 alterations covers removal and replacement of existing materials, elements, equipment or fixtures using like materials that serve the same purpose.

Alterations – Level 2: Level 2 alterations include the reconfiguration of space, the addition or elimination of any door or window, the reconfiguration of any system, or the installation of any additional equipment.

Alterations - Level 3: Level 3 alterations apply where the work area exceeds 50 percent of the aggregate area of the building.

Analysis: The project is Level 3 project, which requires full compliance with all provisions for Level 1, Level 2 and Level 3. The provisions of Chapters 6, 7, and 8 all apply for this project.

New Construction

Level 1, IEBC 602.4: All new work shall comply with materials and methods requirements in the IBC, IECC,

Analysis: The new fixtures, finishes, and replacement equipment must meet the provisions of the code for new construction. The provisions of Level 1 will be met.

Level 2, IEBC 701.3: All new construction elements, components, systems and spaces shall comply with the

requirements of the IBC. Analysis: Fixtures, finishes, and replacement equipment and materials must meet the provisions of the code.

for new construction. In the event the provisions for new construction cannot be met, Compliance

Alternatives may be proposed.

Height and Area Limitations Since the interior structure is new, compliance with current height and area limitations is required.

SECTION R402: RESIDENTIAL BUILDING ENVELOPE REQUIREMENTS (TABLE C402.1.2)

BUILDING ELEMENT	CLIMATE ZONE 5A (A - MOIST) - INSULATIO	ON R-VALUES
CEILING	R-49	
WOOD FRAME WALL	R-20 OR R-13 cavity +R-5ci	****
MASS WALLS	R-13/17°	
FLOORS	R-30 ^b	
ROOF/CEILINGS	R-49 (min. R-30 allowed at 500sf or 20% of tot	al insulated ceiling area - R402.2.2)
BASEMENT WALL	R-15/19 ^c	
SLABd	R-10 AND 2FT DEEP (when slab surface is less	than 12" below grade - R402.2.10)
CRAWL SPACE WALL	R-15/19 ^c	

- R-13ci on interior or exterior of the home or R-17 cavity insulation on the interior of the basement wall
- Alternatively, insulation sufficient to fill the framing cavity and providing not less than an R-value of R-19. R-15ci on entieror or exterior of the home or R-19 cavity insulation on the interior of the basement wall. Alternatively, compliance shall be
- R-5ci on the interior or exterior of the home plus R-13 cavity insulation on interior the basement wall. R-5 insulation shall be provided under full salb area of a heated slab in addition of the ra'd slab edge insulation R-value for slabs, as
- indicated in table. The slab edge insulation for heated slabs shall not be required to extend below the slab.

Primary Structural Frame Fire Resistance Ratings: The table shown below summarizes the requirements for Type IIIB construction. This table is based upon 780 CMR Table 601.

Building Element	IBC Type IIIB (Hours)
Structural frame	
Including columns, girders, trusses	O_B
Bearing walls	
Exterior	2 ^{A, B}
Bearing walls	
Interior	0
Non-Bearing Walls and Partitions	
Exterior	1 ^A
Non-Bearing Walls and Partitions	
Interior	0
Floor Construction	
Including supporting beams and joists	O_B
Roof Construction	
Including supporting beams and joists	0

Analysis: The fire separation distance is 20 feet or greater on the front and rear exterior walls. The allowed percentage of exterior wall openings is unlimited and front and rear walls do not need to be rated unless as Type IIIB if loadbearing. Any exposed exterior wall will need to be fire resistance rated for one hour for exposure from both sides. All exterior walls must be non-combustible in Type IIIB; fire retardant wood is permitted.

The party walls (780 CMR 706.1.1) are considered a shared structural wall between adjacent dwellings and shall be constructed as a 3hr rated fire wall in a R-3, IIIB building.

Not less than rating based on fire separation distance (addressed later in this report) B. Not less than rating of structure supported

Fire resistance Assemblies: The table shown below summarizes the fire resistance ratings for various wall types in the building and their opening protectives:

Building Element	Wall Type	Fire Resistance Rating (Hours)	Opening Protection Rating
Shafts, Stair and Hoistway Enclosures Fire Barr	ier 2 (1°)		90 minutes (60°)
Dwelling Unit Separations, Type IIIB Fire Part			20 ^b
Non-dwelling/Dwelling Unit Separations	Fire Partition	1	45 minutes
Common Area Corridors serving sleeping			
rooms or dwelling units	Fire partition	0.50 ^c	20 ^{ab} minutes
Electrical/Telecom Closets			
Electrical Rooms with xfmr>112.5 kVa	Fire Barrier	1	60 minutes
Emergency Electrical Rooms	Fire Barrier	2	90 minutes
Transformer Vault	Fire Barrier	3 .	180 or 2@90 minute
Fire Pump Room	Fire Barrier	2	90 minutes
Elevator Machine Room	Fire Barrier	2 .	90 minutes
Mechanical Rooms	Referer	nce Table 509 for Incid	dental Uses
a. If connecting 3 stories or less, but not	less than the ratio	ng of the building floor	
b. Doors must be smoke and draft contr	ol doors (780 CM	IR 716.5.3)	
c. Fire resisstance rated supporting cons	struction is not req	uired but the floor slab	is required to have a 30 min r
780 CMR 712.3 Exception.			

780 CMR 420.2 Separation Walls. Walls separating dwelling units in the same building, walls separating sleeping units in the same building and walls separating dwelling or sleeping units from other occupancies contiguous to them in the same building shall be constructed as fire partitions in accordance with Section 708.

709.3 Fire-resistance rating. Fire Partitions shall have a fire-resistance rating of not less than 1 hour. Exception: Dwelling unit and sleeping unit separations in buildings of Type IIB, IIIB and VB construction shall have fire-resistance ratings of not less than 0.5 hour in buildings equipped throughout with an automatic sprinkler system in accordance with Section 903.3.1.1.

Analysis: Walls separating each unit require 0.5 hour fire resistant rating for Type IIIB. Walls separating units from other common use spaces, for example the entry lobby, require a 1 hour rating.

Means of Egress

The means of egress will be via the existing interior stair and the existing exterior fire balcony.

780 CMR 51.00

R311.1 Means of Egress. Dwelling units shall be provided with a primary and secondary means of egress in accordance with this section. Each means of egress shall provide a continuous and unobstructed path of vertical and horizontal egress travel from all portions of the dwelling to the egress doors. The primary means of egress shall not require travel through a garage but the secondary means of egress may. The required egress doors shall open directly into a public way or to a yard or court that opens to a public way.

1. In multi-level dwellings, including but not limited to townhouses, split-level and raised ranch style layouts, the two separate egress doors may be located on different

Analysis: The egress capacity and number of provided exits is compliant.



ARCHITECT

BOSTON, MA 02118

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92 HIGH STREET, SUITE 22 MEDFORD, MA

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APRIL 20, 2022


1/4" = 1'-0"

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MARK ISSUE


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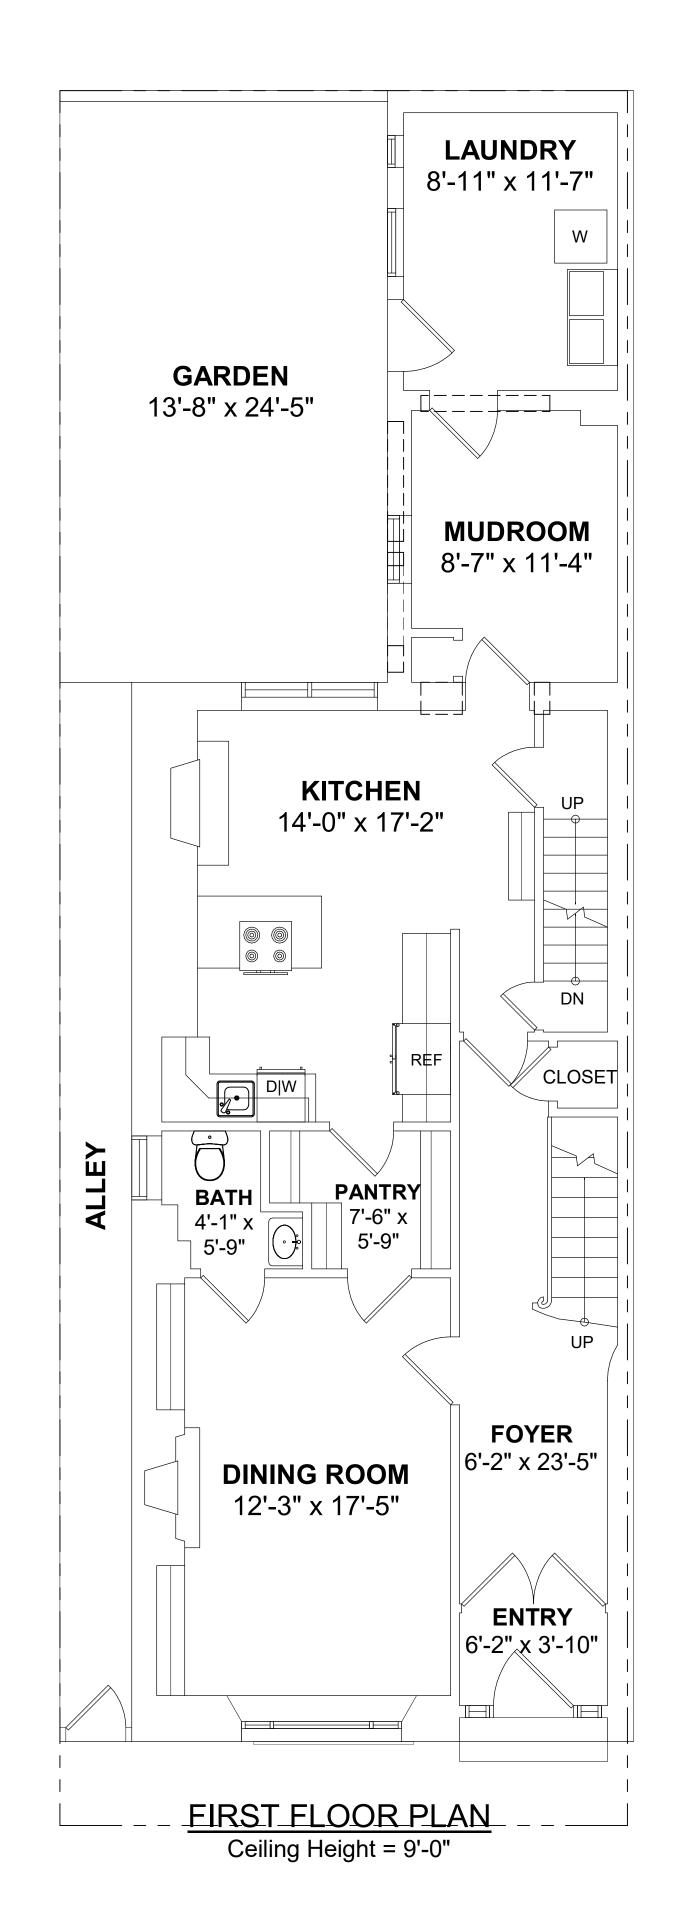
APRIL 20, 2022 PROJECT #: 22010 1 1/2" = 1'-0"


DRAWING TITLE BUILDING INFORMATION

DRAWING NUMBER
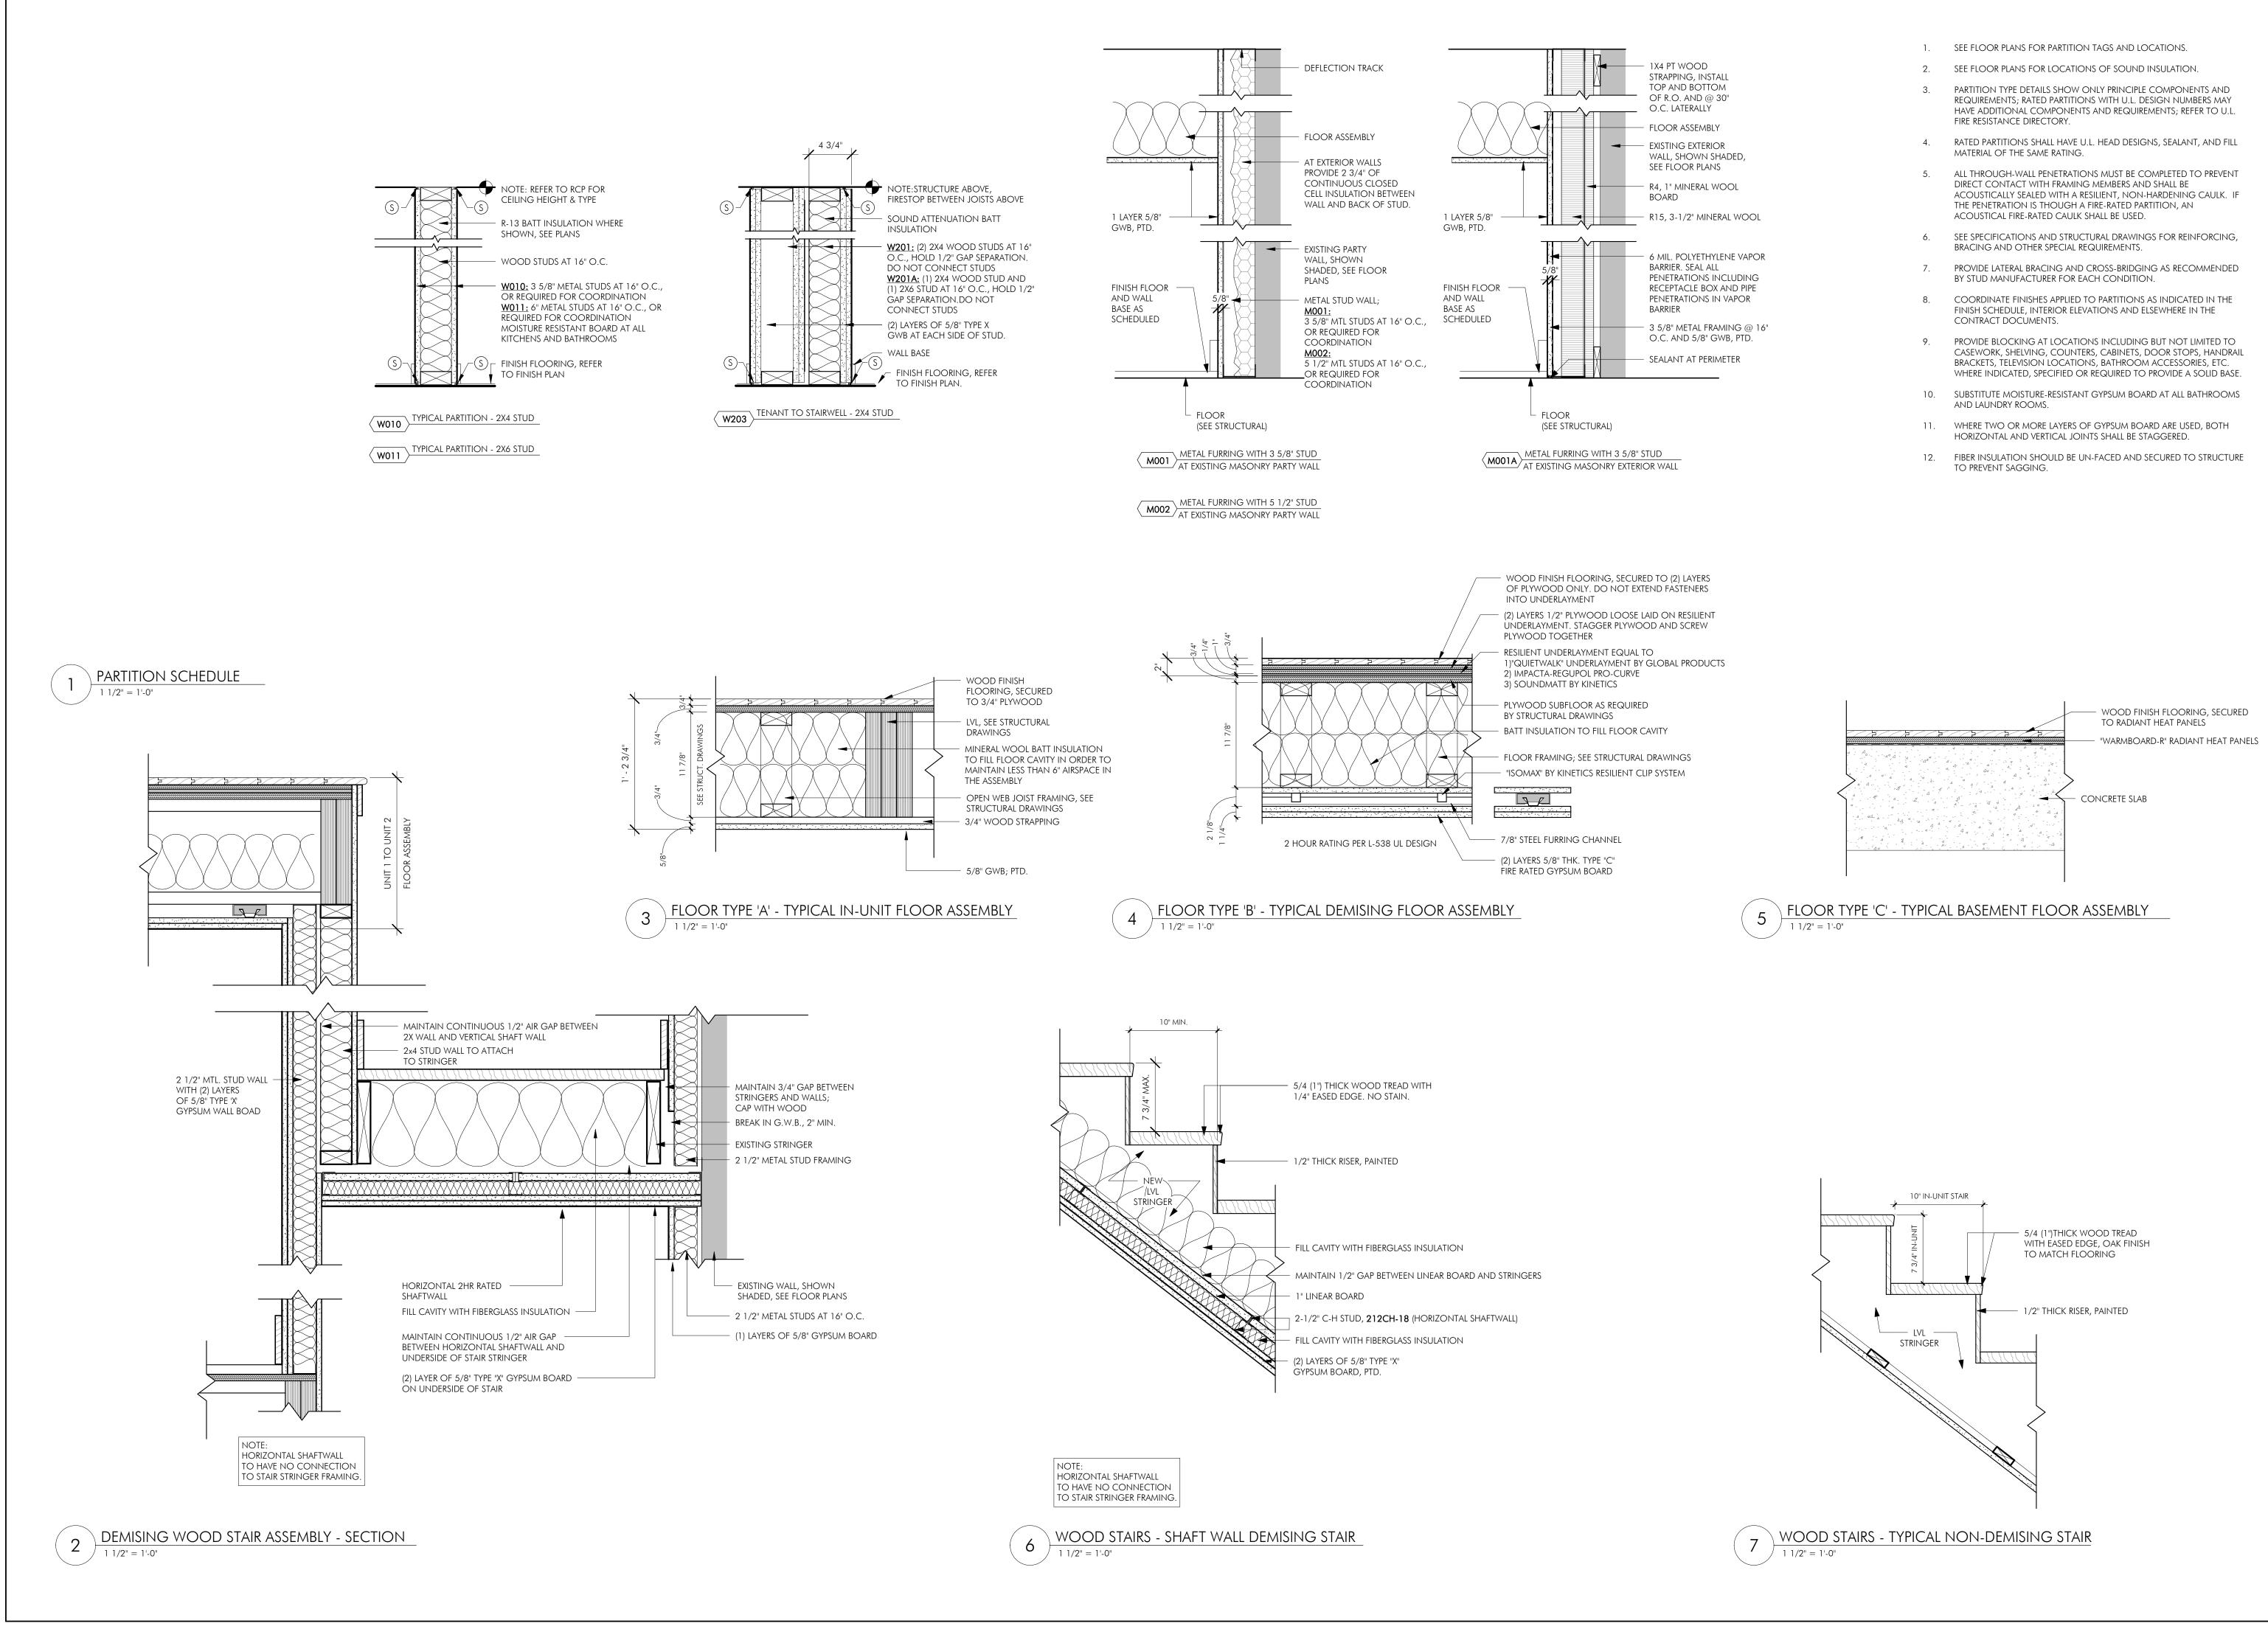
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2 1 - FIRST FLOOR - EXISTING

3 2 - SECOND FLOOR - EXISTING

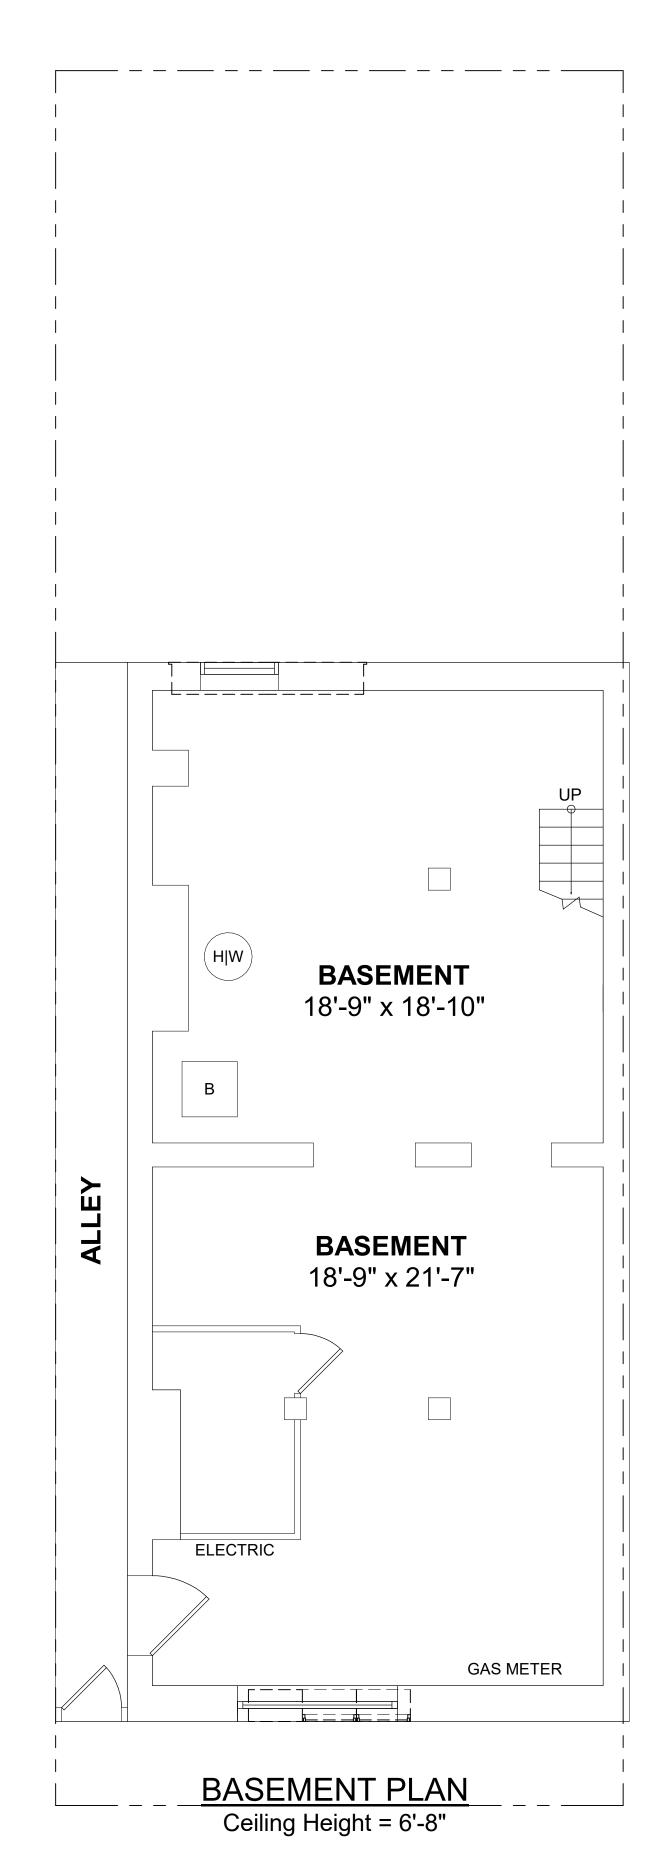0 - BASEMENT - EXISTING 1/4" = 1'-0"

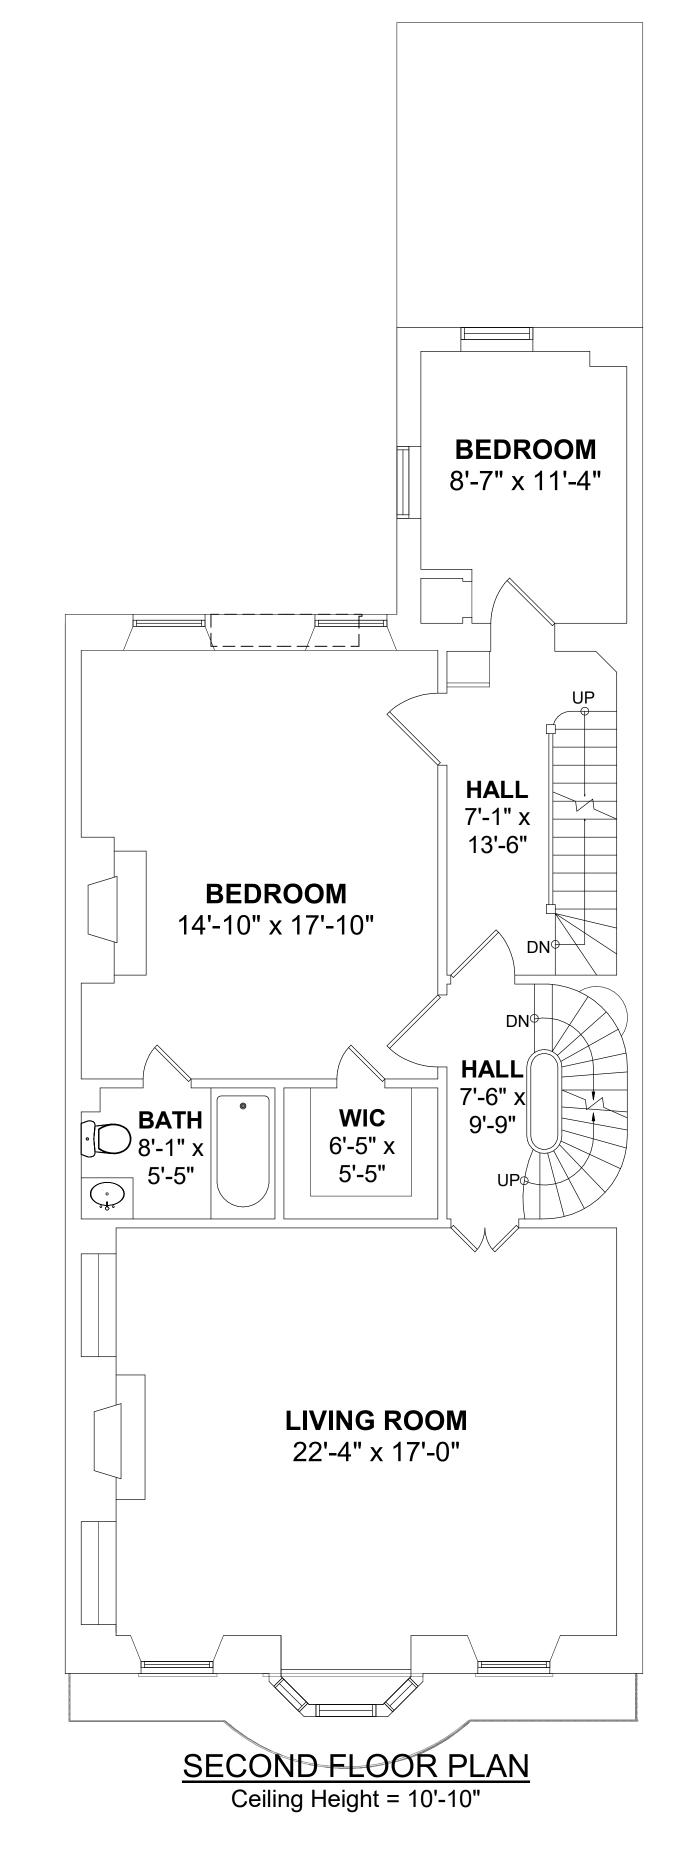6/28/2022 2:17:40 PM

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EMBARC

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OWNER

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92 HIGH STREET, SUITE 22 MEDFORD, MA 02155

CONSULTANTS

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BOSTON, MA 02108
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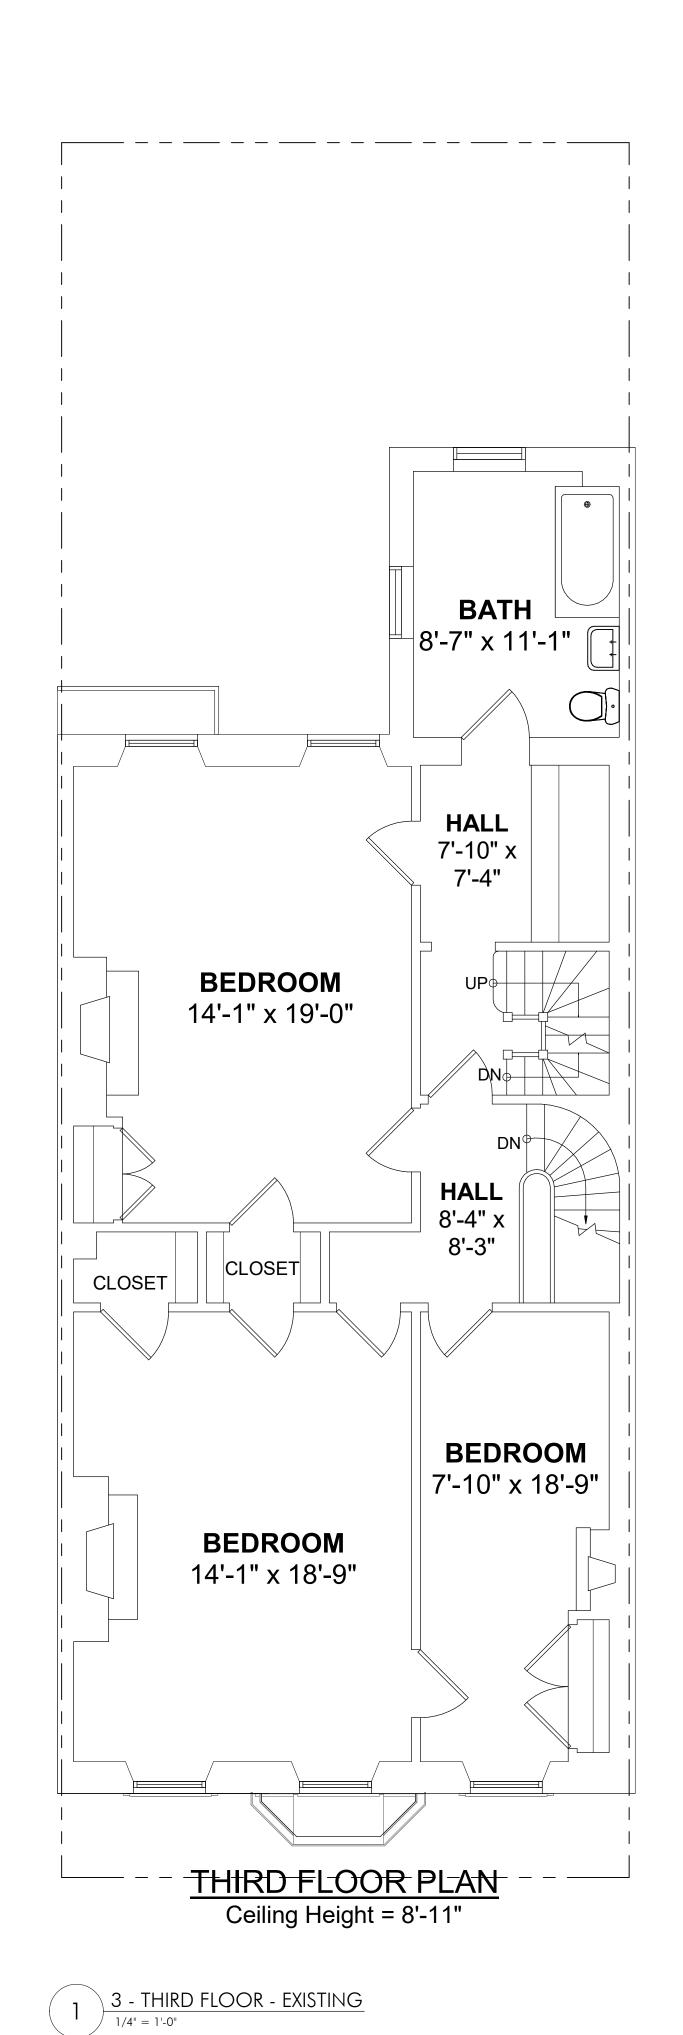
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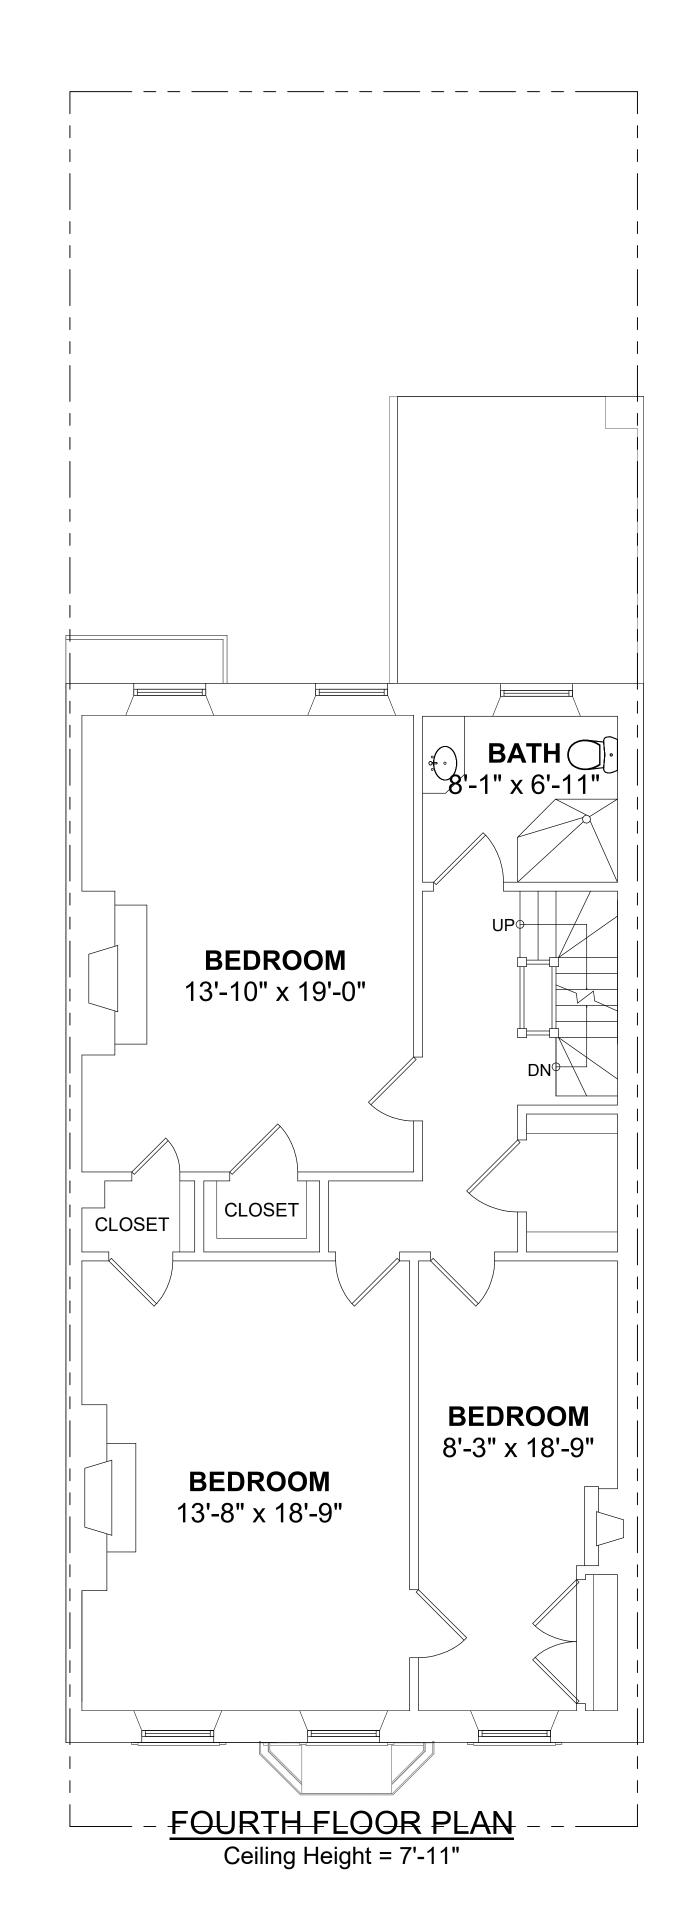
REVISIONS


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EXISTING PLANS







2 4 - FOURTH FLOOR - EXISTING

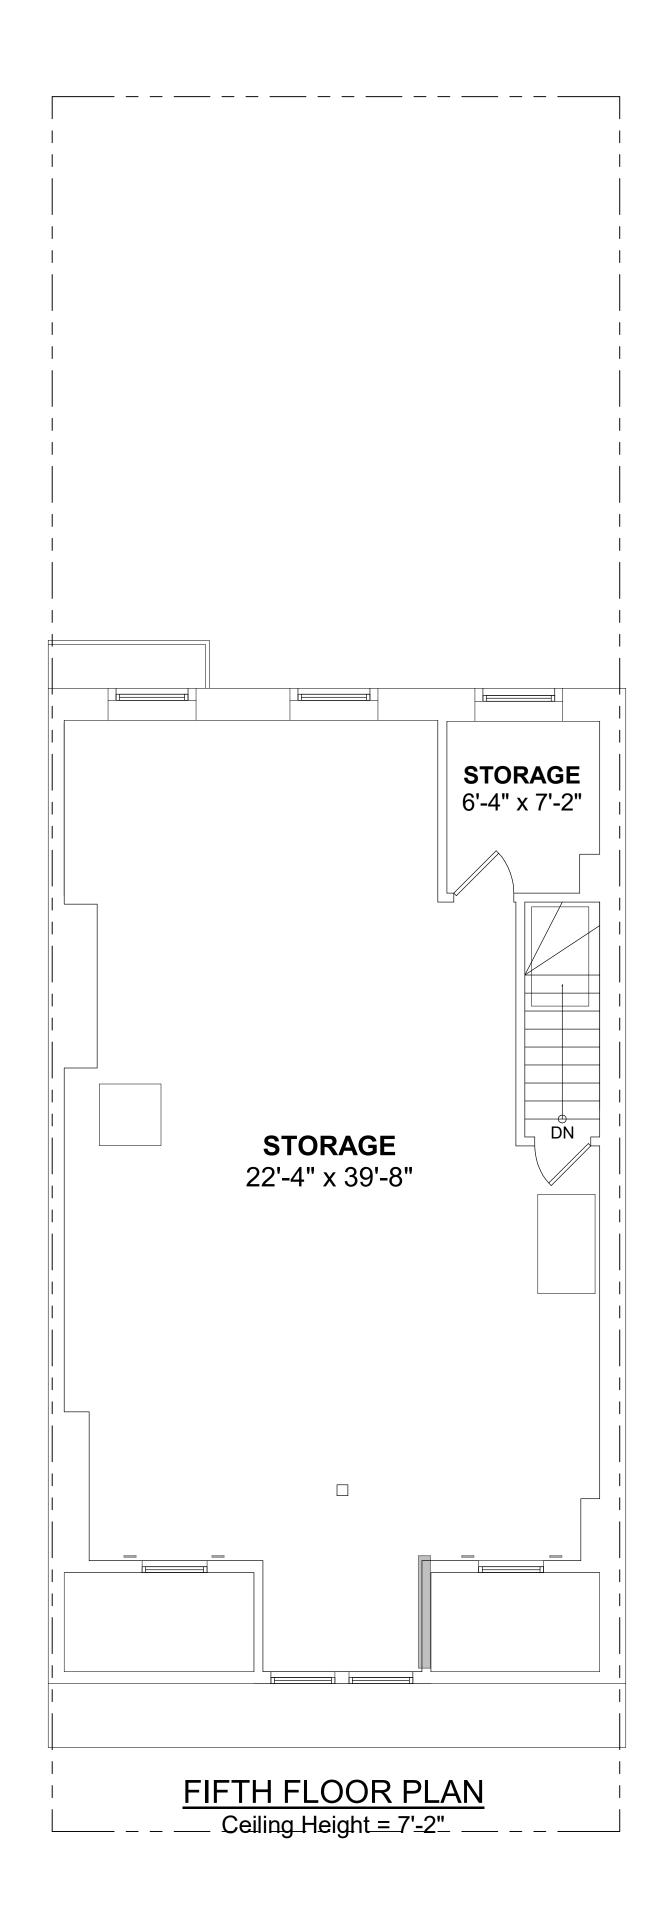3 5 - FIFTH FLOOR - EXISTING

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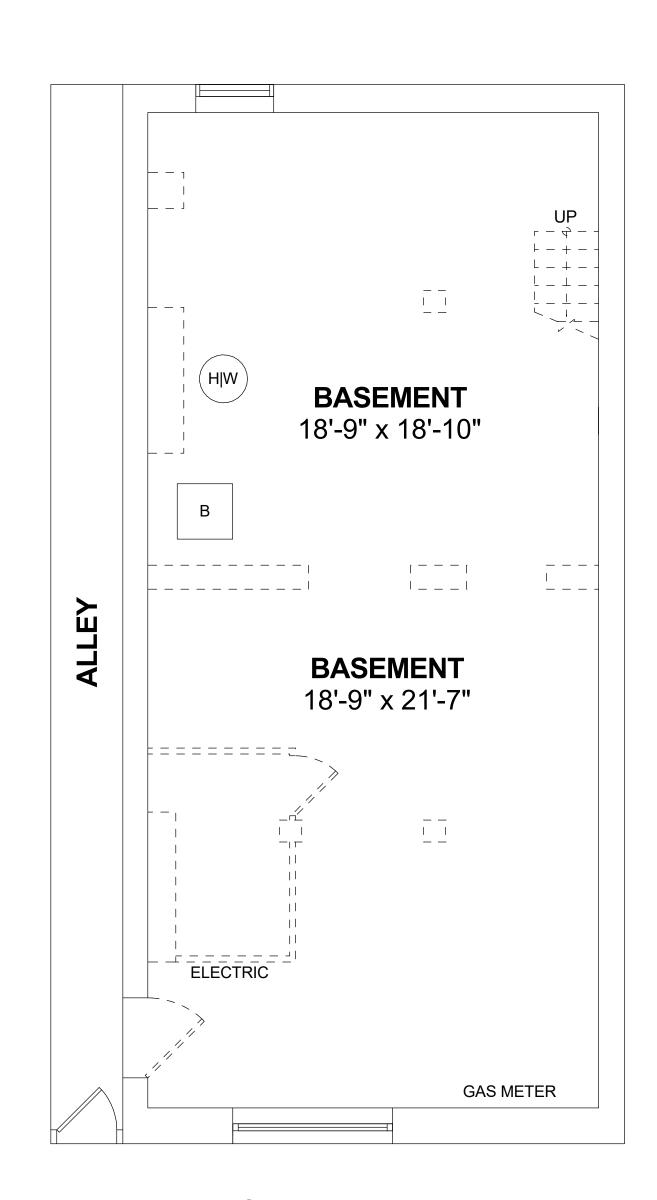
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EXISTING PLANS


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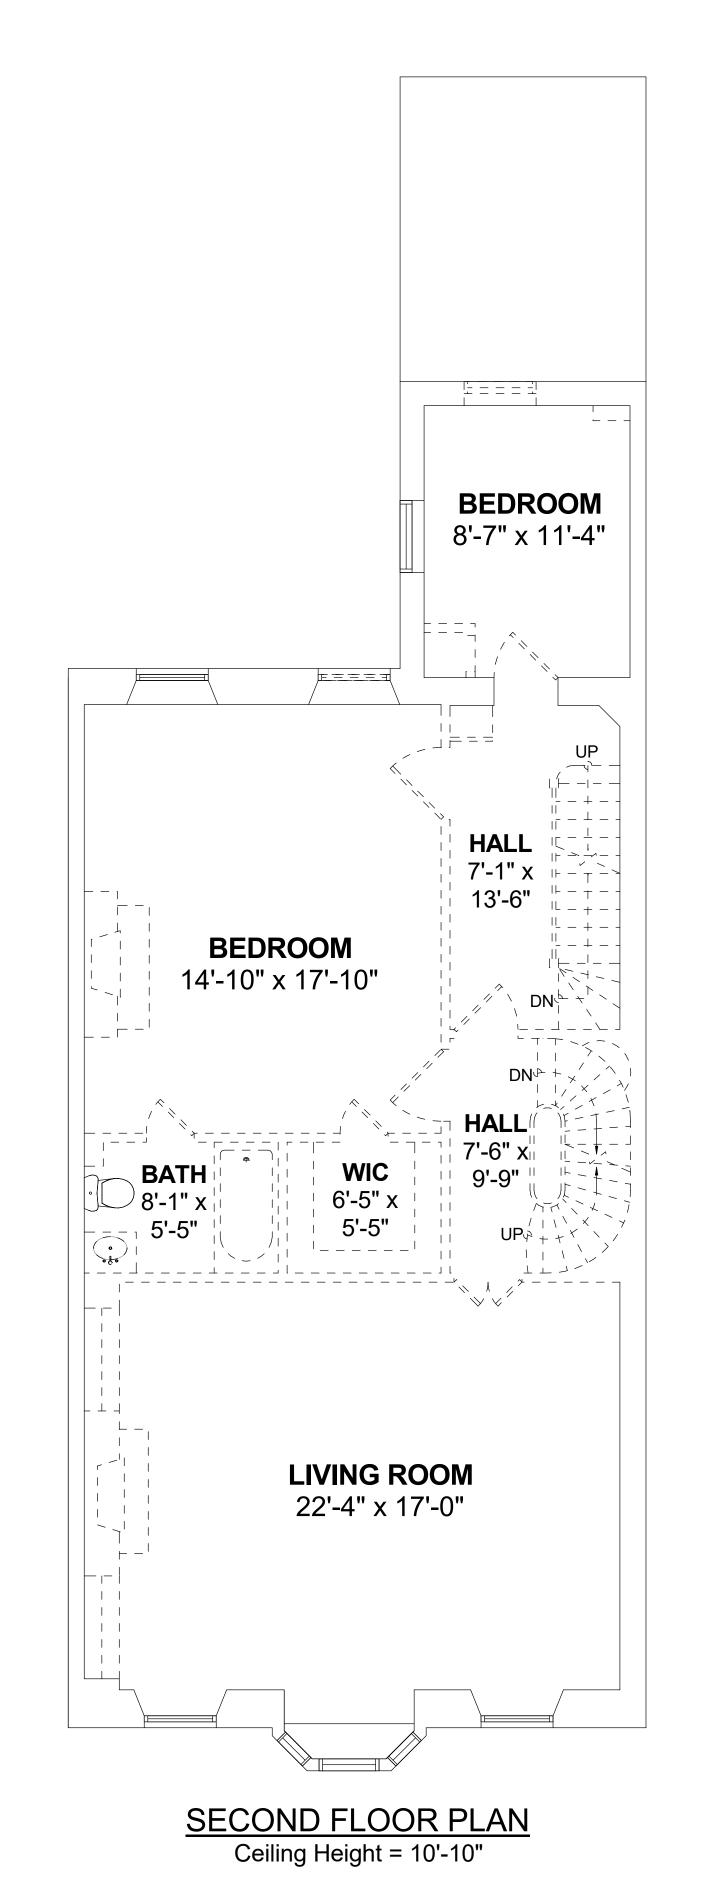
AO11



BASEMENT PLAN
Ceiling Height = 6'-8"



FIRST FLOOR PLAN
Ceiling Height = 9'-0"

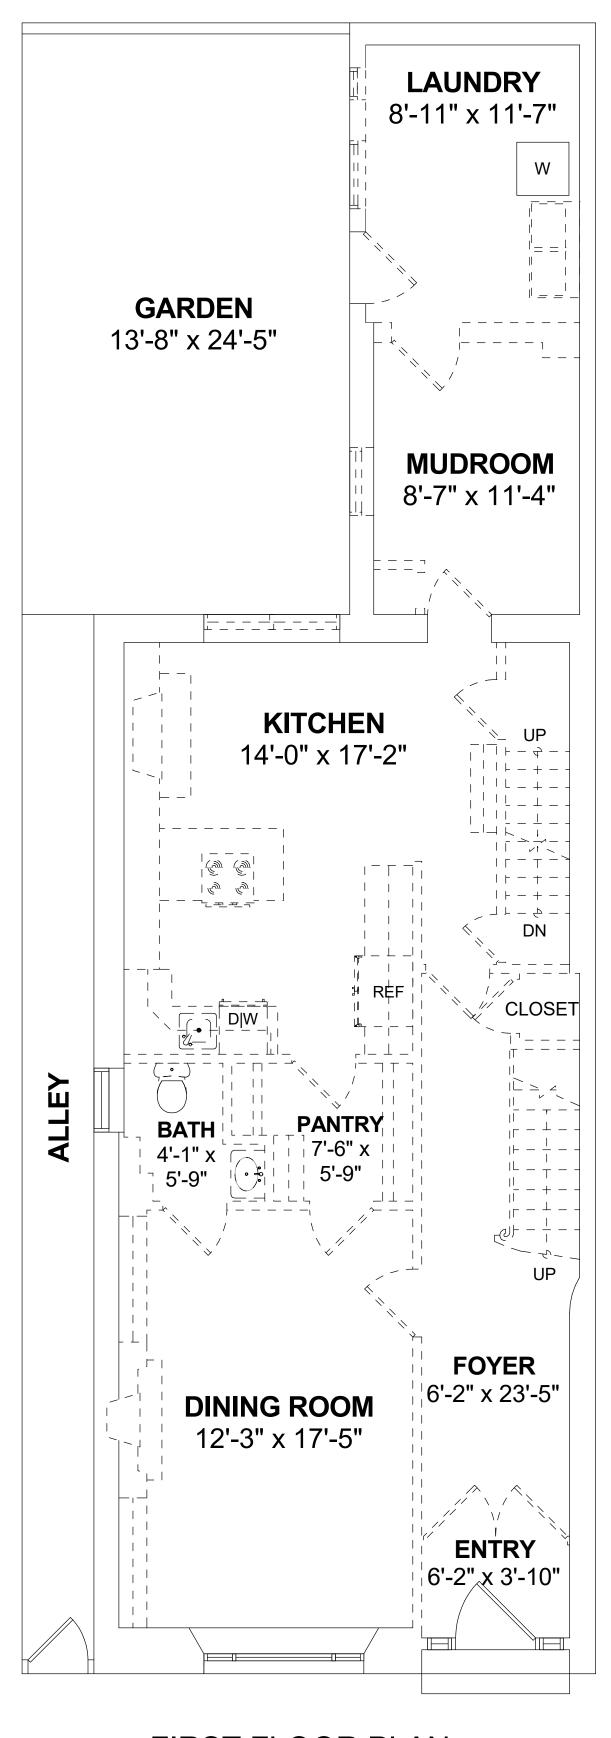

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REVISIONS

7 CHESTNUT BOSTON, MA 02108

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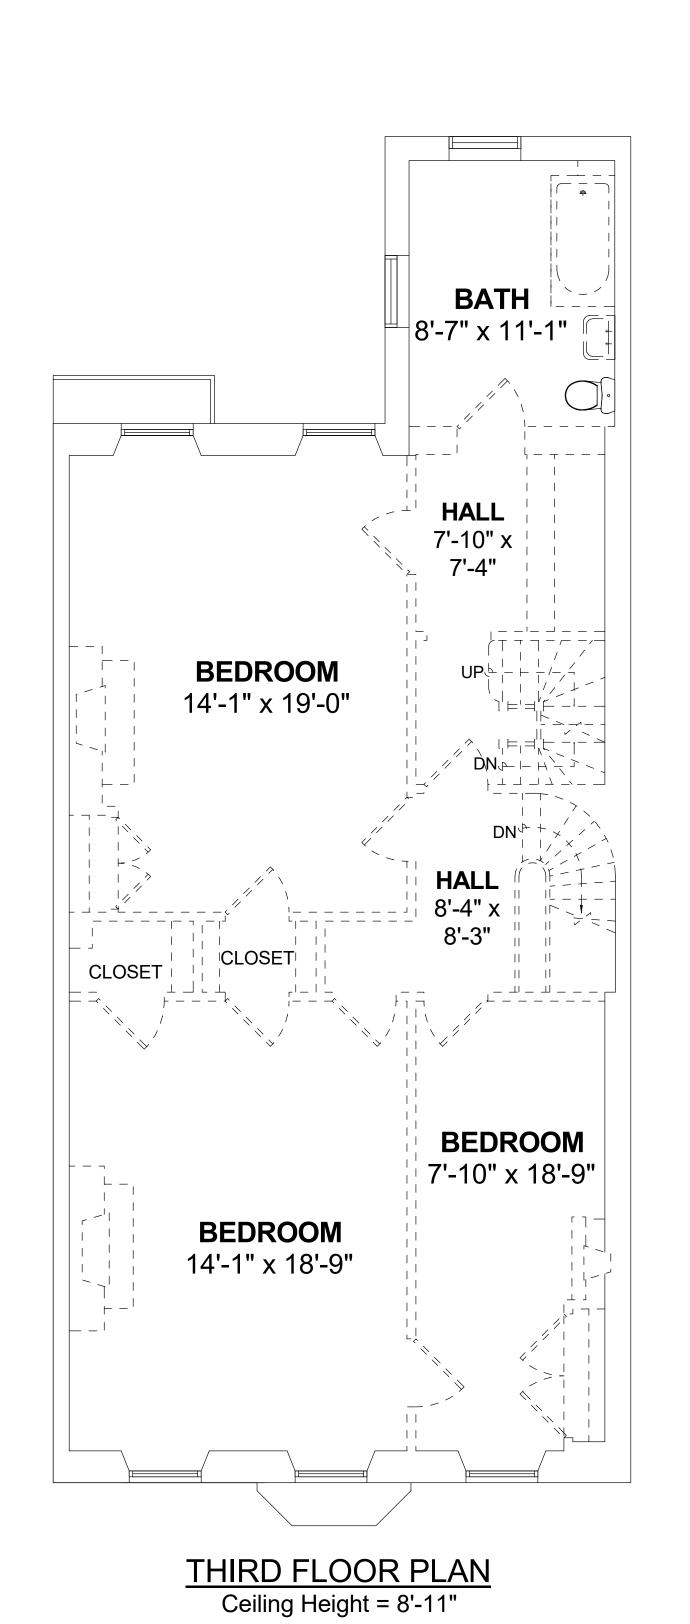
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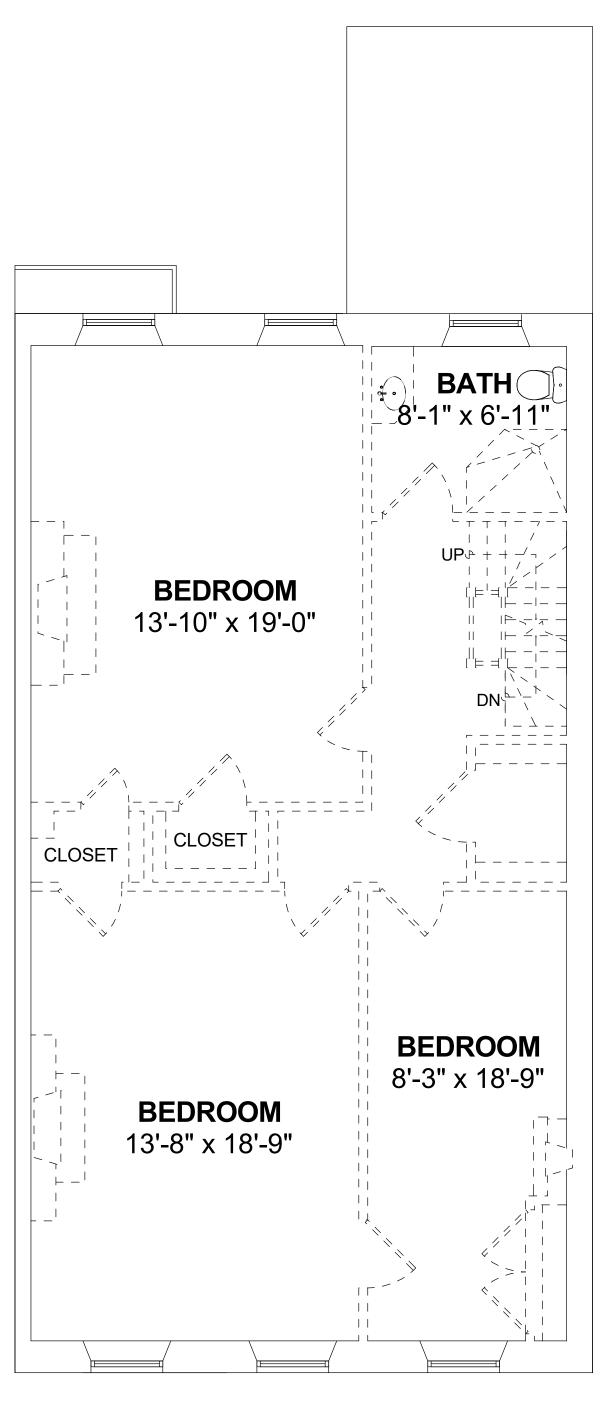
DEMOLITION


PLANS

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D101





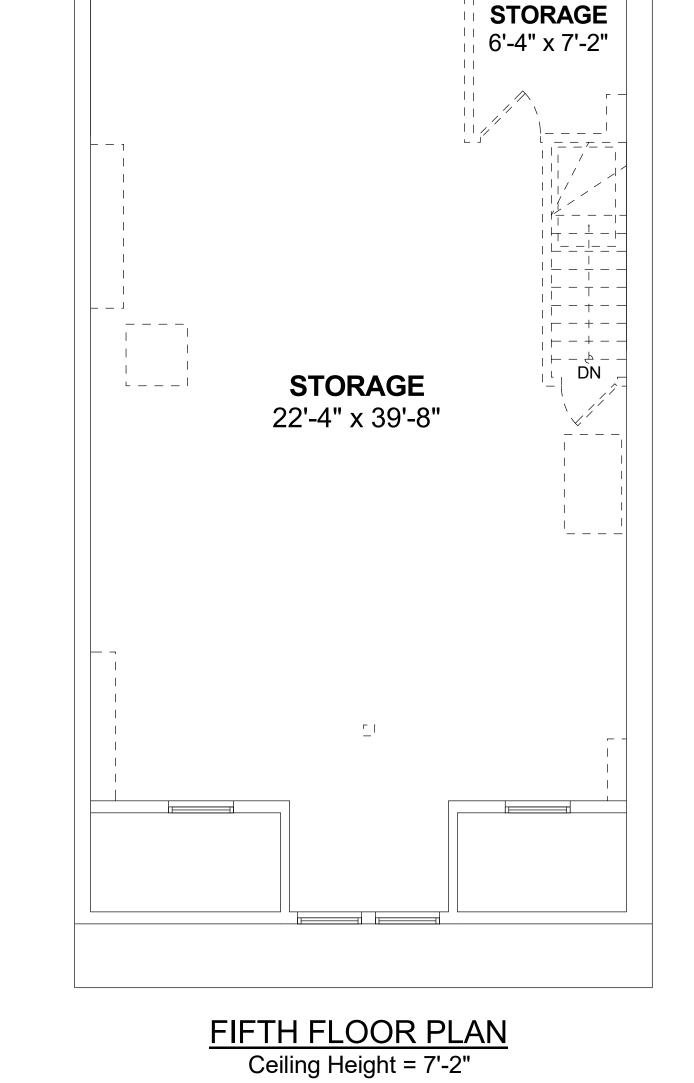

FOURTH FLOOR PLAN
Ceiling Height = 7'-11"



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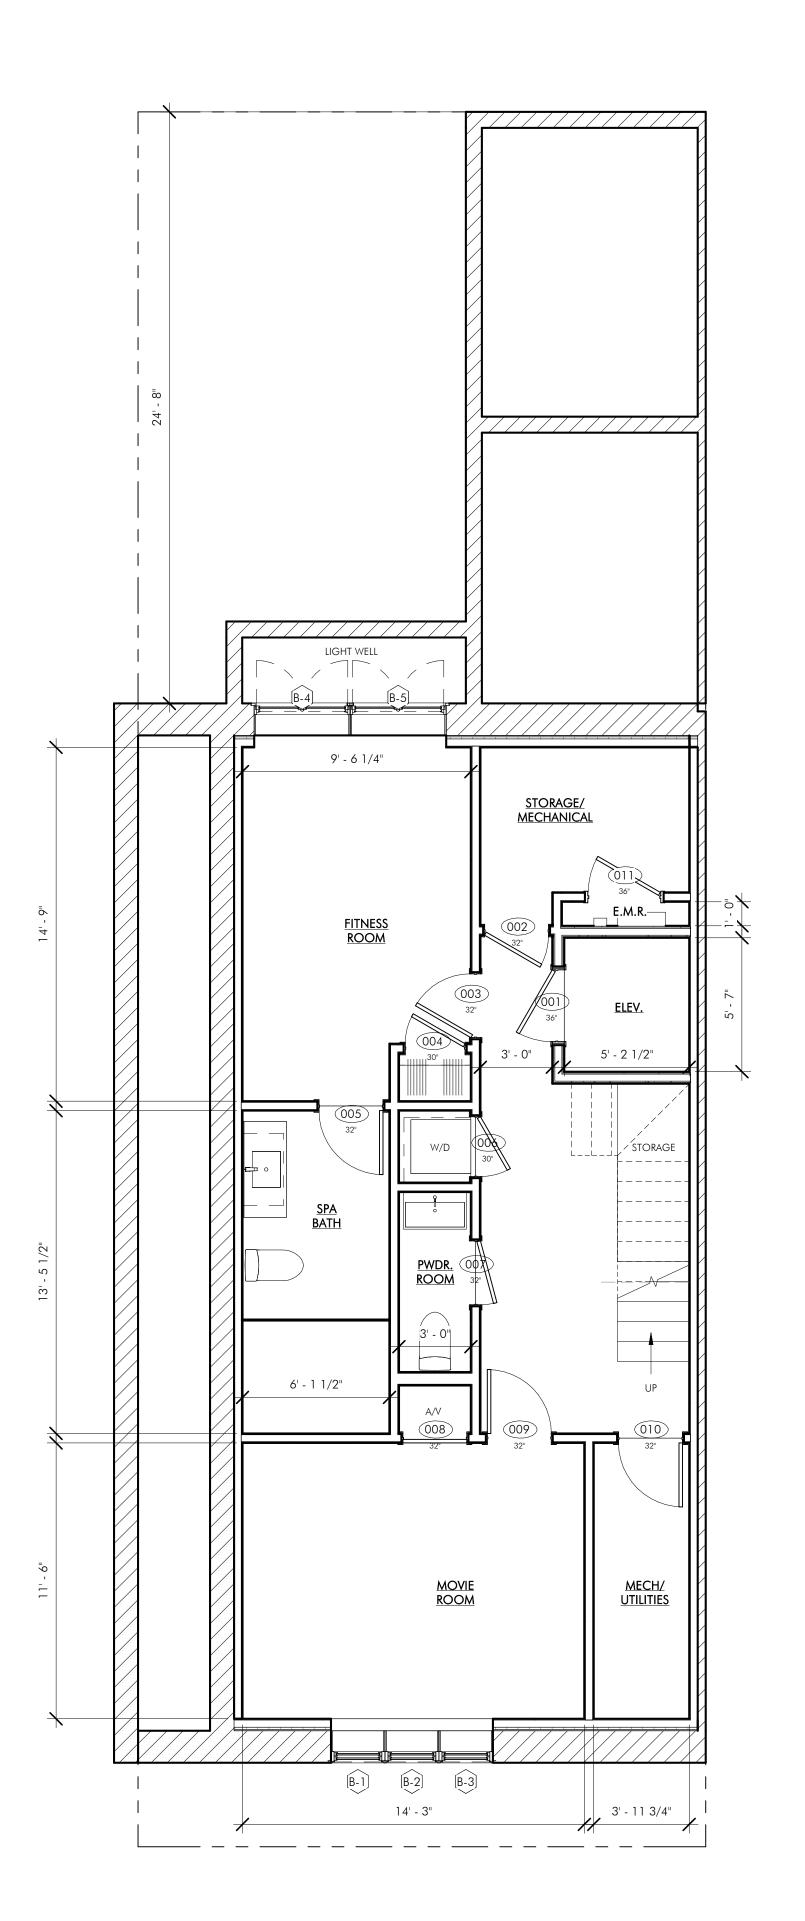
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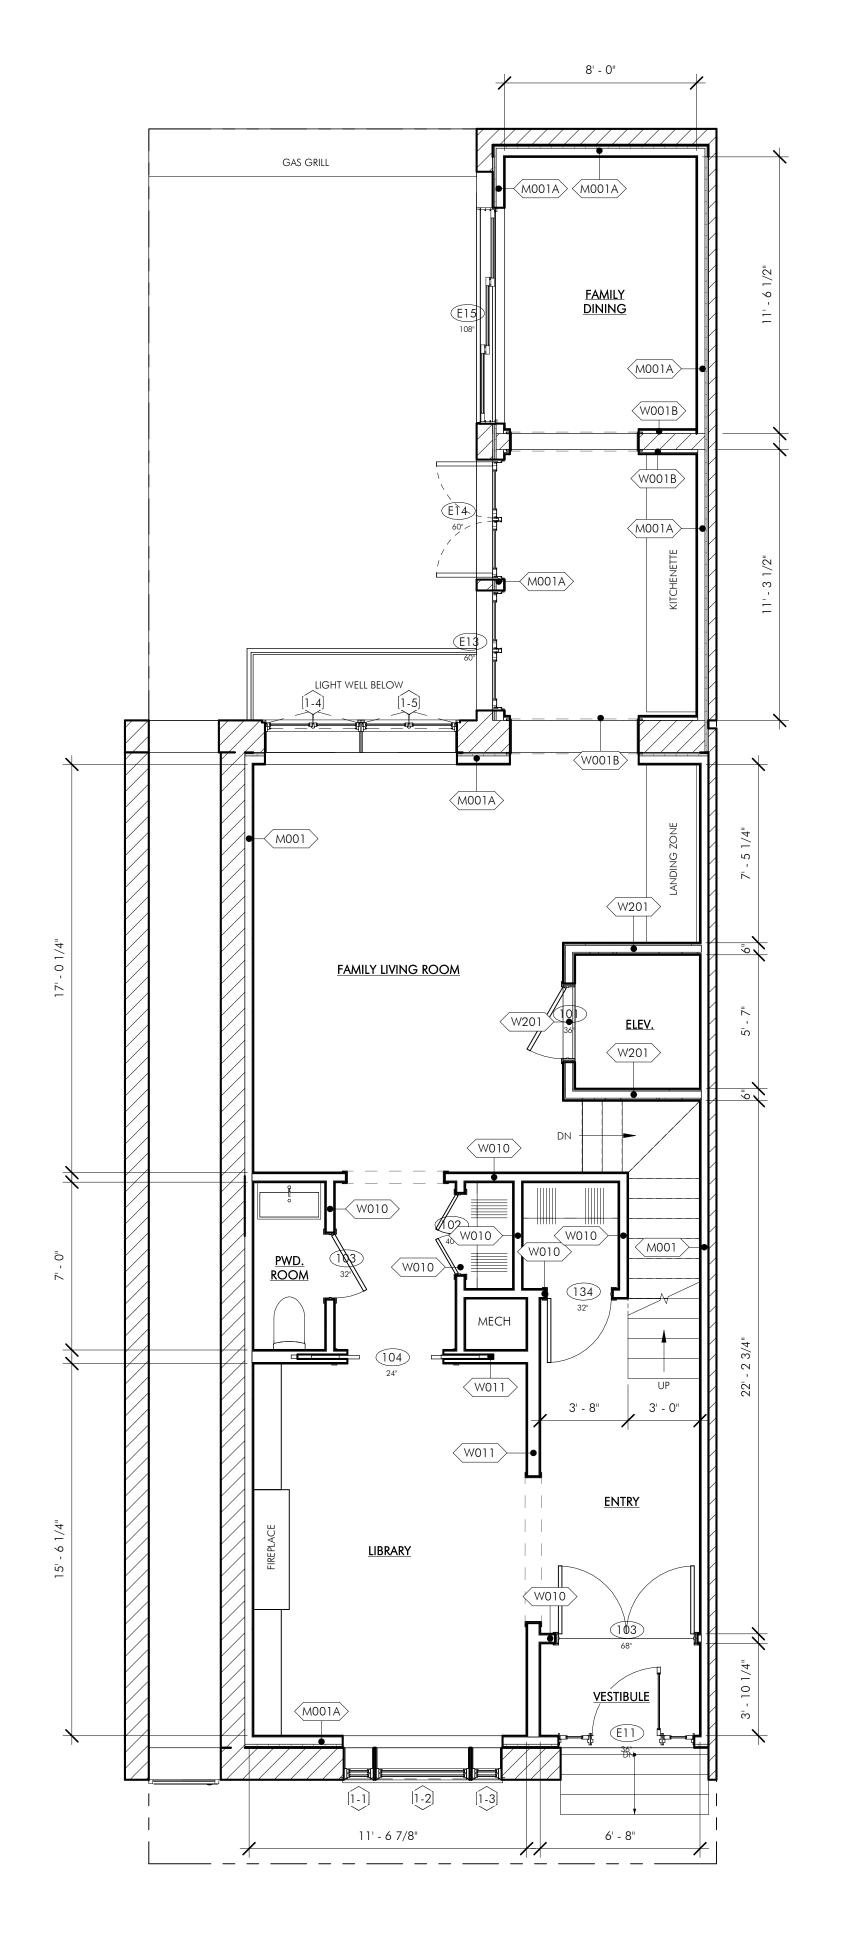
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DEMOLITION
PLANS

DRAWING NUMBER

D102







- WHEN SPECIFIC FEATURES OF CONSTRUCTION ARE NOT FULLY SHOWN ON THE DRAWINGS OR CALLED FOR IN THE GENERAL NOTES, THEIR CONSTRUCTION SHALL BE OF THE SAME CHARACTER AS SIMILAR CONDITIONS.
- 2. ALL DIMENSIONS ARE TO BE TAKEN FROM NUMERIC DESIGNATIONS ONLY;

DIMENSIONS ARE NOT TO BE SCALED OFF THE DRAWINGS.

- 3. ALL INTERIOR DIMENSIONS ARE TO FACE OF FINISH UNLESS OTHERWISE NOTED.
- 4. ALL GYPSUM BOARD SURFACES ARE TO BE 5/8" THICK UNLESS OTHERWISE NOTED.
- 5. ALL GYPSUM AND PLASTER FINISHES SHOULD BE SMOOTH, CONTINUOUS, FREE OF IMPERFECTIONS. AND HAVE NO VISIBLE JOINTS.
- 6 PROVIDE GAS, WATER SPIGOT, OUTLET, AND LIGHTING AT ROOF DECKS; FOR LOCATIONS, SEE FLOOR PLANS AND REFLECTED CEILING PLANS.
- 7. ALL CLOSETS SHALL HAVE SHELF AND POLE OR SHELVES AS REQUIRED, UNLESS OTHERWISE NOTED.
- 8. ALL REQUIRED LIFE SAFETY DEVICES, INCLUDING SMOKE & CARBON MONOXIDE DETECTORS, SHALL BE INSTALLED BY THE CONTRACTOR IN COMPLIANCE WITH THE 2015 INTERNATIONAL BUILDING CODE

PLAN NOTES

- 1. ALL DIMENSIONS ARE MEASURED FROM FACE OF EXISTING BRICK TO FINISH FACE OF G.W.B. OR FROM FINISH FACE OF G.W.B. TO FINISH FACE OF G.W.B.
- 2. ALL DOORS ARE 84" TALL UNLESS OTHERWISE NOTED.
- 3. ALL EXISTING PARTY WALLS AND EXTERIOR WALLS TO RECIEVE FURRING WALL TYPE AS INDICATED ON PLANS

MECHANICAL | SECURITY NOTES

- PROVIDE NEST LEARNING THERMOSTAT AT EACH UNIT. (ZONING PER FLOOR LEVEL IN DUPLEX UNITS)
- 2. HEATING AND AIR CONDITIONING IS TO BE PROVIDED BY HIGH VELOCITY FORCED AIR SPACE PAK HIGH VELOCITY AIR CONDITIONING SYSTEMS WITH HYDRONIC HEATING.
- 3. HOT WATER IS TO BE PROVIDED BY A HIGH EFFICIENCY NAVIEN MODULATING CONDENSING COMBINATION HEATING AND HOT WATER SYSTEM OR EQUAL.

ELECTRICAL NOTES

- 1. ELECTRICAL SERVICE POWER IS TO BE EVALUATED FOR MEETING LIGHTING DESIGN AND EQUIPMENT REQUIREMENTS. PROPER POWER LEVEL SHALL BE PROVIDED.
- 2. ALL NEW ELECTRICAL ITEMS ARE TO BE U.L. RATED.
- 3. ALL ELECTRICAL PANELS ARE TO BE RECESSED INTO A WALL WITH A MINIMUM 6"
 STUD DIMENSION, REVIEW FINAL LOCATION WITH ARCHITECT AND OWNER
- 4. ALL DISTRIBUTION PANELS ARE TO BE NEW.
- 5. LIVING AREAS, DINING AREAS, AND ALL BEDROOM ARE TO RECEIVE 3-WIRE JUNCTION BOXES.
- 6 PROVIDE INTERCOM AND REMOTE ENTRY DOOR ACCESS BY HOUSING DEVICES, INC. OR APPROVED EQUAL.
- 7. PROVIDE ELECTRIC HEAT MATS BY NUHEAT OR EQUAL AT ALL BATHROOMS.
- 8. ALL CLOSET LIGHTING IS TO BE L.E.D. OR HIGH EFFICIENCY LIGHTING.
- 10. ALL SMOKE DETECTORS SHALL RECEIVE THEIR PRIMARY SOURCE OF POWER FROM BUILDING WIRING WITH BATTERY BACK-UP.


9. OUTLETS IN BATHROOMS SHALL HAVE GROUND FAULT INTERCEPTORS.

- 11. ALL DIMENSIONS FOR THE FOLLOWING ITEMS ARE TO FINISH SURFACES UNLESS OTHERWISE NOTED:
- A. MOUNT ALL OUTLETS, PHONE JACKS, AND TELEVISION CABLE JACKS VERTICALLY AT 18" TO CENTERLINE ABOVE THE FINISH FLOOR UNLESS OTHERWISE NOTED. WHERE BASE AND TRIM IS LARGER THAN 9-1/2" TALL PROVIDE 6" CLEARANCE FROM BOTTOM OF PLATE TO TOP OF BASEBOARD
- TRIM.

 B. MOUNT ALL SWITCHES AT 42" TO CENTERLINE ABOVE FINISH FLOOR UNLESS OTHERWISE NOTED.

 C. VERTICALLY ALIGN SWITCHES AND OUTLETS WHERE POSSIBLE.

FLOOR PLAN LEGEND

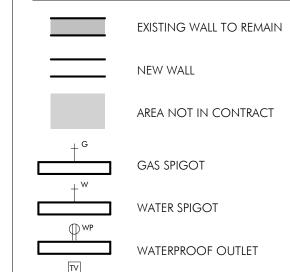


TV LOCATION

SV

STRUCTURED VI

STRUCTURED VIDEO LOCATION

THERMOSTAT LOCATION

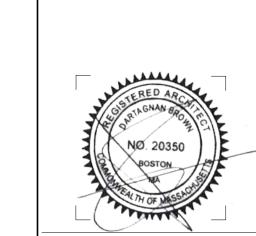

REVISIONS

MARK ISSUE

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| ARCHITECT

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OWNER

DRAWING INFORMATION


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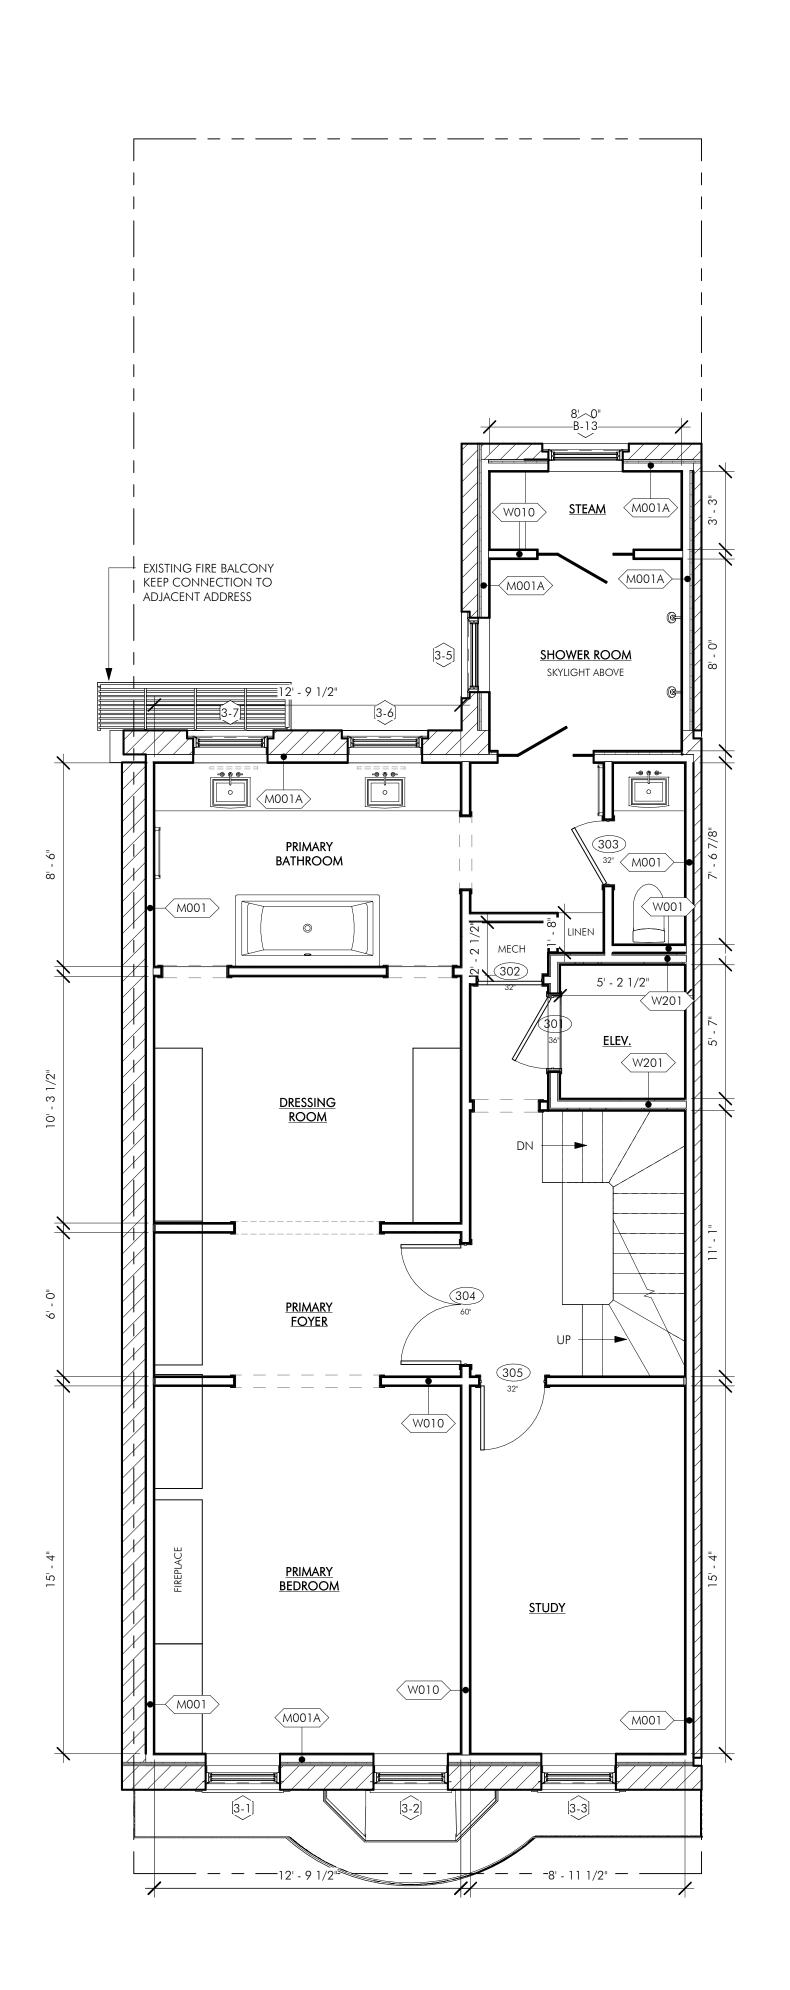
CONSTRUCTION

DRAWING NUMBER

PLANS

A101



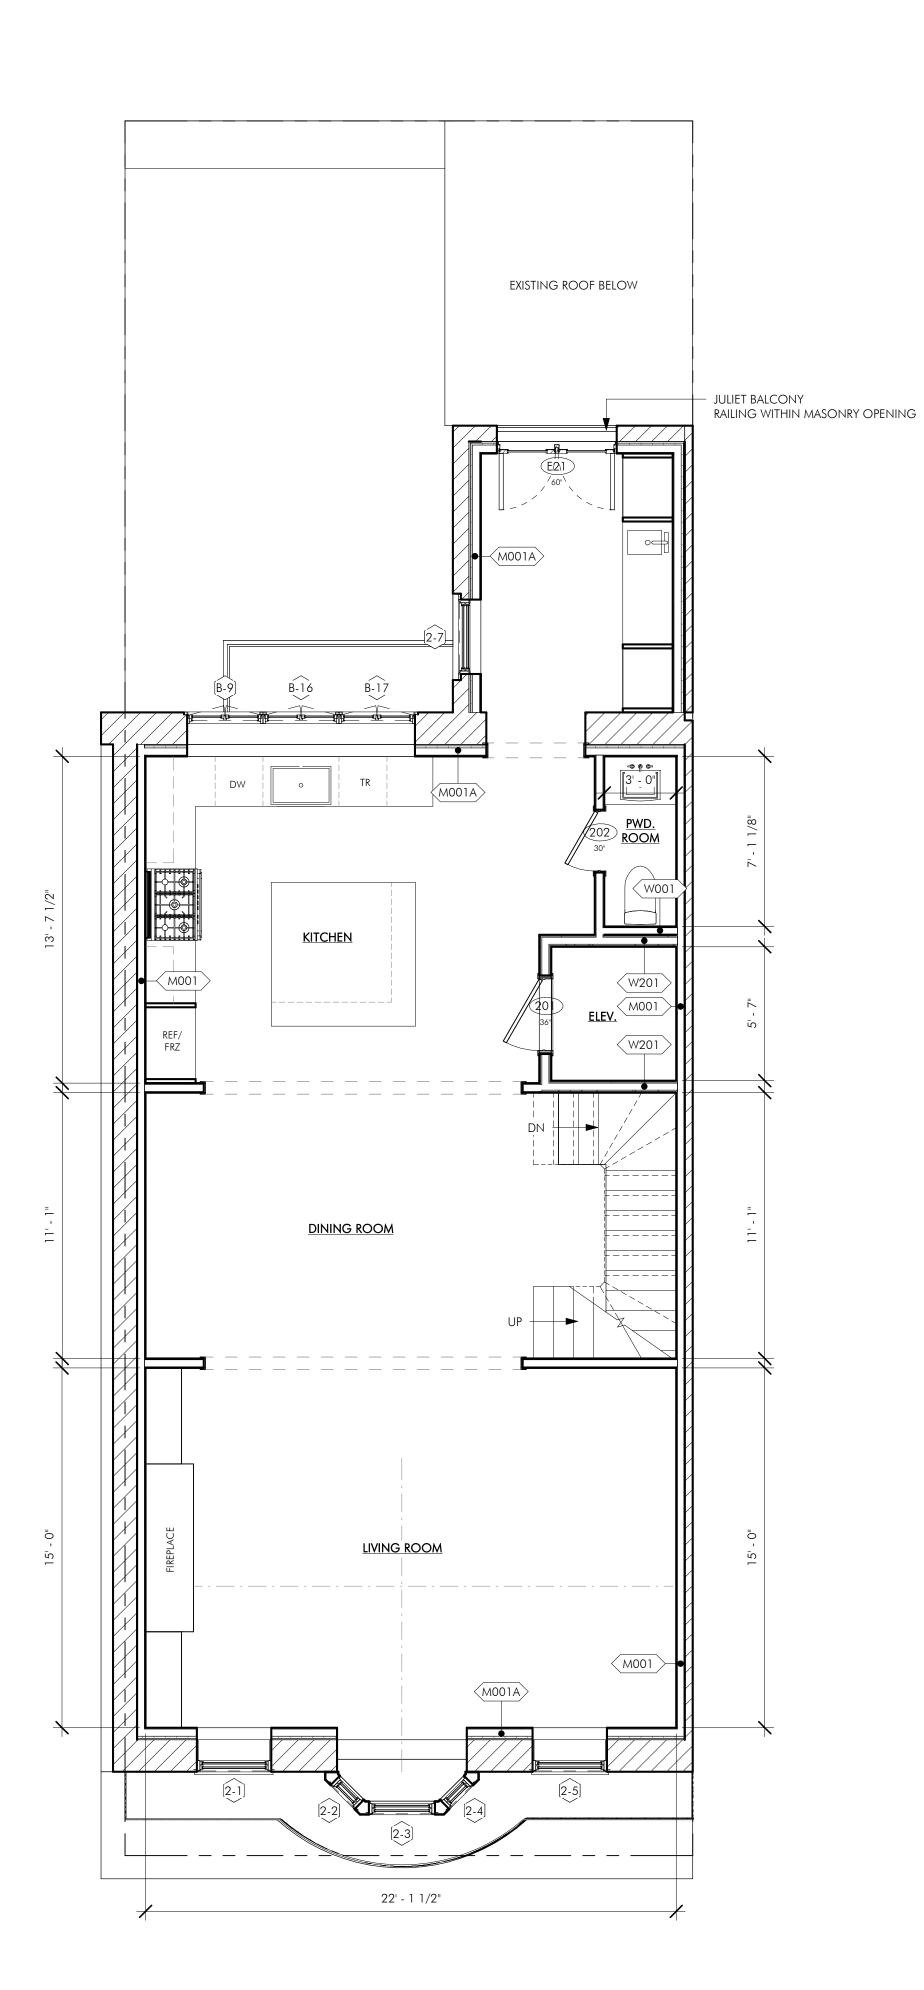



- 1. WHEN SPECIFIC FEATURES OF CONSTRUCTION ARE NOT FULLY SHOWN ON THE DRAWINGS OR CALLED FOR IN THE GENERAL NOTES, THEIR CONSTRUCTION SHALL BE OF THE SAME CHARACTER AS SIMILAR CONDITIONS.
- 2. ALL DIMENSIONS ARE TO BE TAKEN FROM NUMERIC DESIGNATIONS ONLY;

DIMENSIONS ARE NOT TO BE SCALED OFF THE DRAWINGS.

- 3. ALL INTERIOR DIMENSIONS ARE TO FACE OF FINISH UNLESS OTHERWISE NOTED.
- 4. ALL GYPSUM BOARD SURFACES ARE TO BE 5/8" THICK UNLESS OTHERWISE NOTED.
- 5. ALL GYPSUM AND PLASTER FINISHES SHOULD BE SMOOTH, CONTINUOUS, FREE OF IMPERFECTIONS. AND HAVE NO VISIBLE JOINTS.
- 6 PROVIDE GAS, WATER SPIGOT, OUTLET, AND LIGHTING AT ROOF DECKS; FOR LOCATIONS, SEE FLOOR PLANS AND REFLECTED CEILING PLANS.
- 7. ALL CLOSETS SHALL HAVE SHELF AND POLE OR SHELVES AS REQUIRED, UNLESS OTHERWISE NOTED.
- 8. ALL REQUIRED LIFE SAFETY DEVICES, INCLUDING SMOKE & CARBON MONOXIDE DETECTORS, SHALL BE INSTALLED BY THE CONTRACTOR IN COMPLIANCE WITH THE 2015 INTERNATIONAL BUILDING CODE

PLAN NOTES

- 1. ALL DIMENSIONS ARE MEASURED FROM FACE OF EXISTING BRICK TO FINISH FACE OF G.W.B. OR FROM FINISH FACE OF G.W.B. TO FINISH FACE OF G.W.B.
- 2. ALL DOORS ARE 84" TALL UNLESS OTHERWISE NOTED.
- 3. ALL EXISTING PARTY WALLS AND EXTERIOR WALLS TO RECIEVE FURRING WALL TYPE AS INDICATED ON PLANS


MECHANICAL | SECURITY NOTES

- 1. PROVIDE NEST LEARNING THERMOSTAT AT EACH UNIT. (ZONING PER FLOOR LEVEL IN DUPLEX UNITS)
- 2. HEATING AND AIR CONDITIONING IS TO BE PROVIDED BY HIGH VELOCITY FORCED AIR SPACE PAK HIGH VELOCITY AIR CONDITIONING SYSTEMS WITH HYDRONIC HEATING.
- 3. HOT WATER IS TO BE PROVIDED BY A HIGH EFFICIENCY NAVIEN MODULATING CONDENSING COMBINATION HEATING AND HOT WATER SYSTEM OR EQUAL.

ELECTRICAL NOTES

- 1. ELECTRICAL SERVICE POWER IS TO BE EVALUATED FOR MEETING LIGHTING DESIGN AND EQUIPMENT REQUIREMENTS. PROPER POWER LEVEL SHALL BE PROVIDED.
- 2. ALL NEW ELECTRICAL ITEMS ARE TO BE U.L. RATED.
- 3. ALL ELECTRICAL PANELS ARE TO BE RECESSED INTO A WALL WITH A MINIMUM 6"
- 4. ALL DISTRIBUTION PANELS ARE TO BE NEW. 5. LIVING AREAS, DINING AREAS, AND ALL BEDROOM ARE TO RECEIVE 3-WIRE
- JUNCTION BOXES. 6 PROVIDE INTERCOM AND REMOTE ENTRY DOOR ACCESS BY HOUSING DEVICES,
- INC. OR APPROVED EQUAL.
- 7. PROVIDE ELECTRIC HEAT MATS BY NUHEAT OR EQUAL AT ALL BATHROOMS.
- 8. ALL CLOSET LIGHTING IS TO BE L.E.D. OR HIGH EFFICIENCY LIGHTING.
- 9. OUTLETS IN BATHROOMS SHALL HAVE GROUND FAULT INTERCEPTORS.
- 10. ALL SMOKE DETECTORS SHALL RECEIVE THEIR PRIMARY SOURCE OF POWER FROM BUILDING WIRING WITH BATTERY BACK-UP.
- 11. ALL DIMENSIONS FOR THE FOLLOWING ITEMS ARE TO FINISH SURFACES UNLESS OTHERWISE NOTED:
- A. MOUNT ALL OUTLETS, PHONE JACKS, AND TELEVISION CABLE JACKS VERTICALLY AT 18" TO CENTERLINE ABOVE THE FINISH FLOOR UNLESS OTHERWISE NOTED. WHERE BASE AND TRIM IS LARGER THAN 9-1/2" TALL PROVIDE 6" CLEARANCE FROM BOTTOM OF PLATE TO TOP OF BASEBOARD
- B. MOUNT ALL SWITCHES AT 42" TO CENTERLINE ABOVE FINISH FLOOR UNLESS C. VERTICALLY ALIGN SWITCHES AND OUTLETS WHERE POSSIBLE.

FLOOR PLAN LEGEND

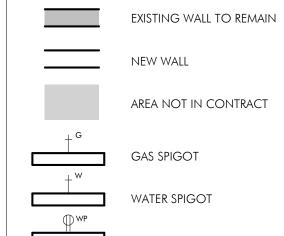

WATERPROOF OUTLET TV LOCATION

STRUCTURED VIDEO LOCATION

THERMOSTAT LOCATION

| ARCHITECT BOSTON, MA 02118

www.embarcstudio.com OWNER

O: 617.765.8000

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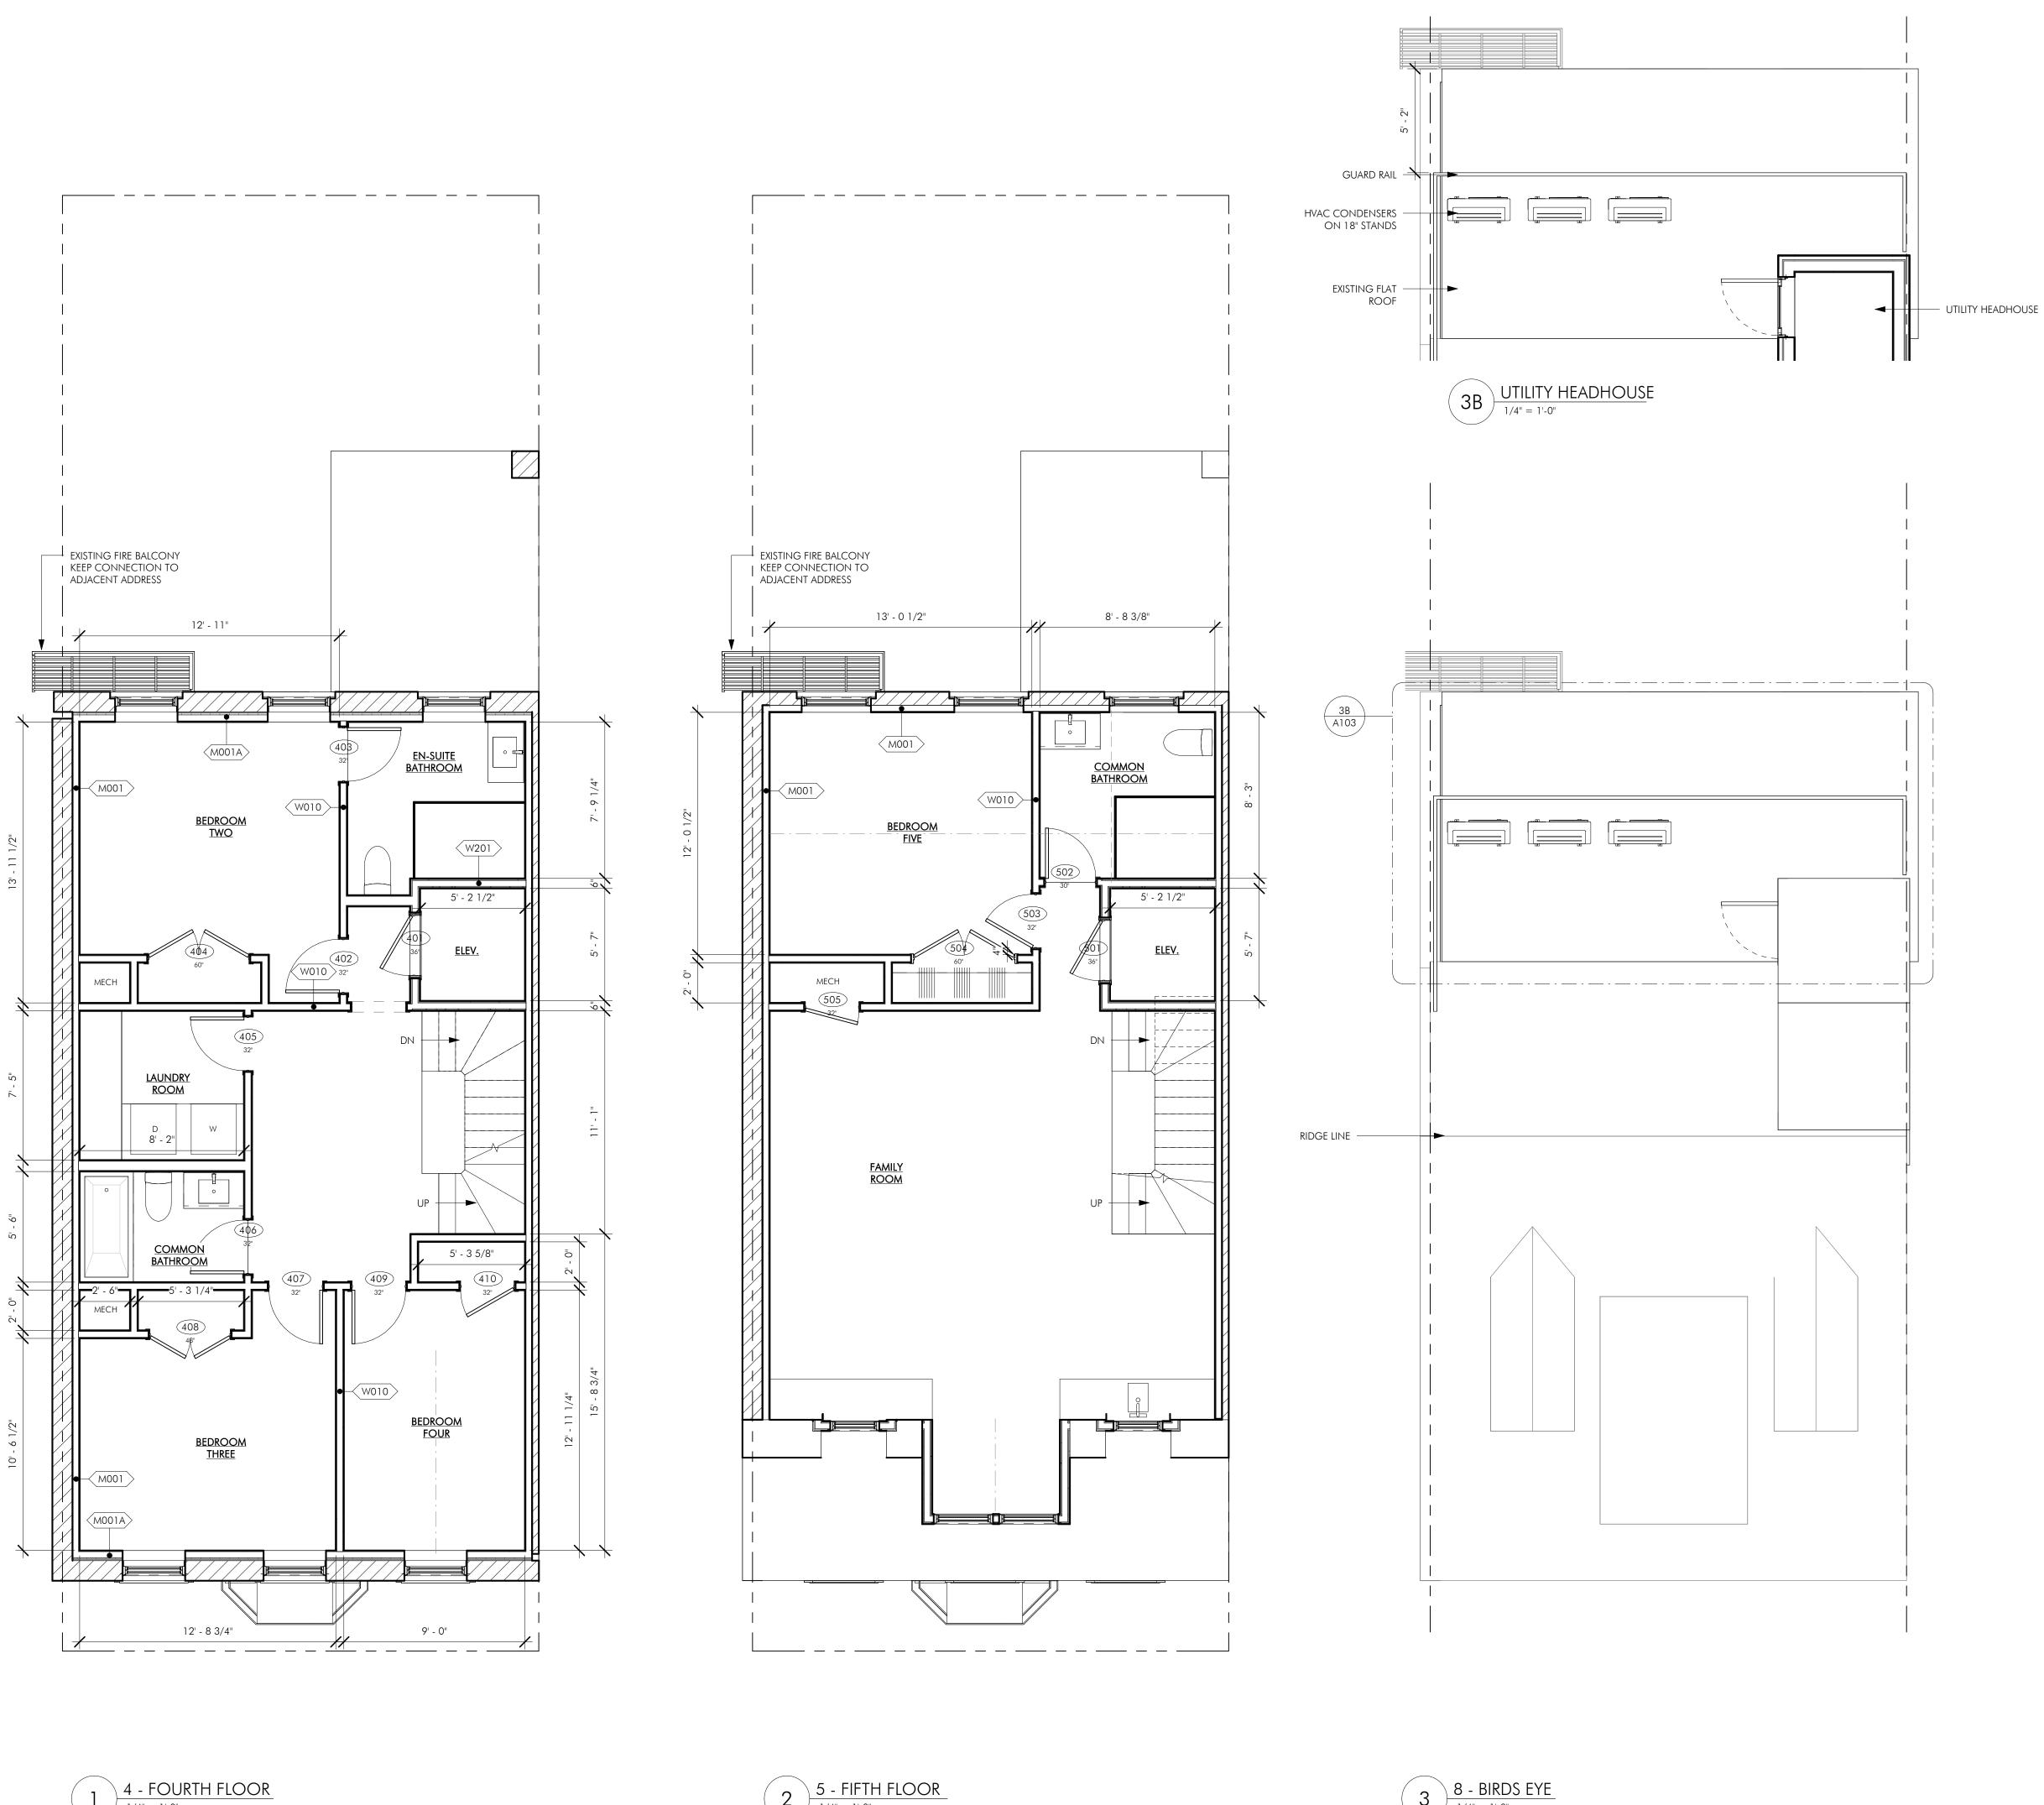
ISSUE: ISSUED FOR CONSTRUCTION APRIL 20, 2022 PROJECT #: 22010

1/4" = 1'-0"

DRAWING TITLE CONSTRUCTION

DRAWING NUMBER

PLANS



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FLOOR PLAN LEGEND

EXISTING WALL TO REMAIN NEW WALL AREA NOT IN CONTRACT GAS SPIGOT WATER SPIGOT

WATERPROOF OUTLET TV LOCATION

STRUCTURED VIDEO LOCATION

THERMOSTAT LOCATION

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DRAWING INFORMATION ISSUE: ISSUED FOR CONSTRUCTION

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| ARCHITECT

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CONSULTANTS

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APRIL 20, 2022 PROJECT #: 22010 1/4" = 1'-0"

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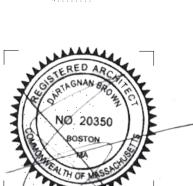
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REVISIONS

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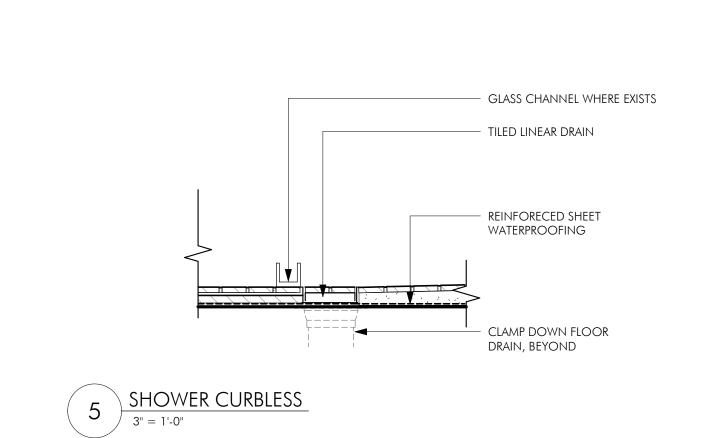
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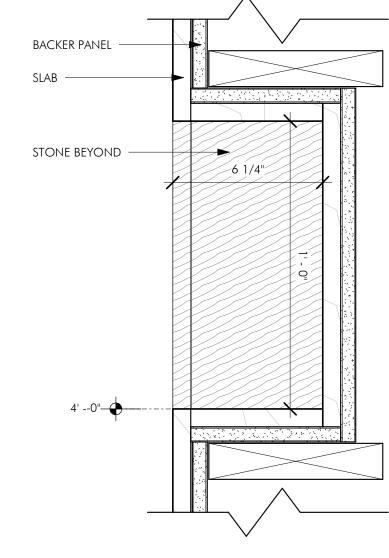
ISSUE: <u>ISSUED FOR CONSTRUCTION</u> APRIL 20, 2022

PROJECT #: 22010 1/4" = 1'-0"


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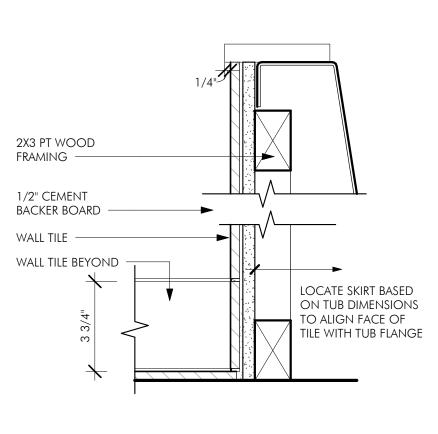








BATHROOM FLOOR ASSEMBLY




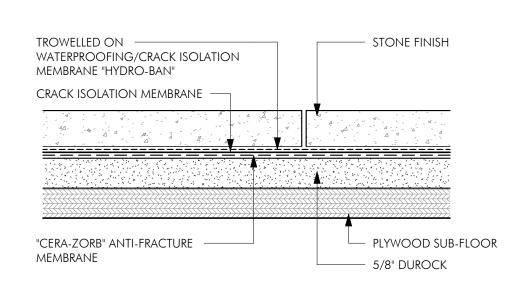

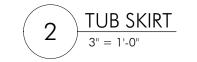

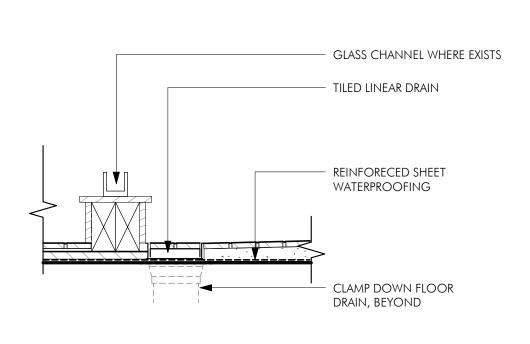



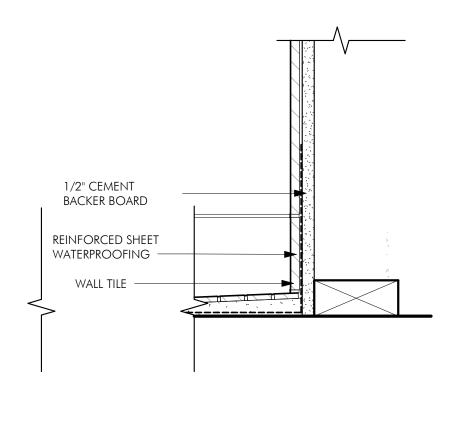



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ISSUE: ISSUED FOR CONSTRUCTION

DATE: APRIL 20, 2022

ISSUE: ISSUED FOR CONSTRUCT

DATE: APRIL 20, 2022

PROJECT #: 22010

SCALE: As indicated

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DRAWING TITLE
INTERIOR DETAILS

DRAWING NUMBER

A501

580 HARRISON AVE, SUITE 2W BOSTON, MA 02118 O: 617.765.8000 www.embarcdesign.com OWNER 7 CHESTNUT STREET LLC 92 HIGH STREET, SUITE 22 MEDFORD, MA 02155 CONSULTANTS CHESTNU STON, MA 02108 ISSUED REVISIONS MARK ISSUE DATE NOTES: 1 1/2" - 6" 1. APPLY IN-SEAM SEALANT 1/2" FROM INSIDE EDGE OF PIPE SEAL FLANGE TO THE DECK FLANGES OF THE PRE-MOLDED PIPE PREMOLDED PIPE SEAL MUST HAVE INTACT RIB AT TOP EDGE, REGARDLESS OF PIPE DIAMETER FLASHING SHALL NOT BE OVERLAPPED, CUT, OR APPLIED OVER ANY ANGLE CHANGE — STAINLESS STL CLAMPING RING - WATER CUT-OFF MASTIC PRE-MOLDED PIPE, SEAL AS SPECIFIED — IN-SEAM SEALANT. (SEE NOTE 1) ____ LAP SEALANT - EPDM MEMBRANE ROOFING — ROOF INSULATION DRAWING INFORMATION ISSUE: ISSUED FOR CONSTRUCTION — SEAL ALL PENETRATIONS DATE: <u>APRIL 20, 2022</u> PROJECT #: 22010 VAPOR BARRIER SCALE: 3" = 1'-0" SEAL VAPOR BARRIER TO ALL PIPE PENETRATIONS DRAWING TITLE EXTERIOR DETAILS 1 SECTION AT PIPE FLASHING AT MEMBRANE ROOFING

3" = 1'-0" DRAWING NUMBER

ARCHITECT EMBARC