7 CHESTNUT

BOSTON, MA 02108

AUGUST 30, 2022 ISSUED FOR CONSTRUCTION

ABBREVIATIONS

ABOVE FINISHED FLOOR ACT ACOUSTICAL CEILING TILE ADA AMERICANS W/ DISABILITIES ACT APPROX. APPROXIMATE ARCH. ARCHITECTURAL **AUDIO VISUAL** BLDG. BUILDING BLKG. BLOCKING B.O. BOTTOM OF CAB. CABINET C.H. CEILING HEIGHT CLR. CLEAR CENTERLINE COL. COLUMN CONT. CONTINUOUS CMU CONCRETE MASONRY UNIT C.J. CONTROL JOINT DETAIL DIA. DIAMETER DIMENSION DOWN DRAWING

DWG. existing ELEVATION ELEC. ELECTRICAL EQ EQUAL FD. FLOOR DRAIN F.O. FACE OF F.O.C. FACE OF CONCRETE

F.O.F.

GFIC GROUND FAULT INTERCEPTOR CIRCUIT GALVANIZED SHEET METAL GSM. GWB GYPSUM WALL BOARD

FACE OF FINISH

H OR HVAC HEATING, VENTILATING, AND AIR CONDITIONING H.B. HOSE BIB HOLLOW METAL MAX. MAXIMUM M.O. MASONRY OPENING MECH. MECHANICAL

MEP MECHANICAL ELECTRICAL PLUMBING MIN. MINIMUM MISC. MISCELLANEOUS MTL. METAL N.I.C. NOT IN CONTRACT NO. NUMBER N.T.S. NOT TO SCALE


OVER O.C. ON CENTER O.D. OUTSIDE DIAMETER OPNG. **OPENING** OPP. **OPPOSITE** P.G. PAINT GRADE PLYWD. PLYWOOD PTD. PAINTED ROOF DRAIN REQ'D. REQUIRED R.O.

SCHED. S.G. STAIN GRADE SIMILAR S.L.D. SQ. SPEC. SPECIFICATION S.S.D. SEE STRUCTURAL DRAWINGS SSTL. STAINLESS STEEL

STEEL STL. STOR. STORAGE STRUCT. STRUCTURAL SYM. SYMMETRICAL **TEMPERED** T&G THK. T.O. TOP OF

TUBULAR STEEL T.S. TYP. TYPICAL U.O.N V.I.F. VERIFY IN FIELD

WD. WPM. SYMBOLS

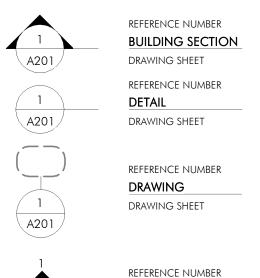

INTERIOR ELEVATION DRAWING SHEET REFERENCE NUMBER EXTERIOR ELEVATION DRAWING SHEET NORTH ARROW

WINDOW TAG DOOR TAG WALL TYPE TAG APPLIANCE TAG revision tag

CENTER LINE



VICINITY MAP



PROJECT DATA

LEVEL	COMMON	RESIDENTIAL
GARDEN	0	913
FIRST	0	1160
SECOND	0	1174
THIRD	0	1165
FOURTH	0	1045
FIFTH	0	903
TOTAL GSF =	0 GSF	6360 GSF

COMMON AREA	0 SF	A. USE GROUP:
UNIT 1	6,360 SF	residential R-3 (residential, one dwelling uni
		B. CONSTRUCTION CLASSIFICATION:
TOTAL	6,360 GSF	TYPE 3-B CONSTRUCTION


C. FULLY SPRINKLERED


ZONING REVIEW


	ALLOWABLE	EXISTING	PROPOSED
LOT SIZE	NONE	1,665 S.F.	NO CHANGE
LOT WIDTH	NONE	23' - 8"	NO CHANGE
F.A.R. (2.0)	3,330 S.F. (2.0)	5,447 S.F. (3.27)	6,360 (3.82)
BUILDING HEIGHT	65'-0"	± 58'-0"	62'-8"
FRONT YARD	20'-0"	± 3'-6"	NO CHANGE
SIDE YARD	0'-0"	0'-0"	NO CHANGE
REAR YARD	30'-0"	± 24'-8"	NO CHANGE


SHEET LIST


NUMBER	NAME		
A000	COVER		
A001	CODE REVIEW		
A002	BUILDING INFORMATION		
A010	EXISTING PLANS		
A011	EXISTING PLANS		
D101	DEMOLITION PLANS		
D102	DEMOLITION PLANS		
A101	CONSTRUCTION PLANS		
A102	CONSTRUCTION PLANS		
A103	CONSTRUCTION PLANS		
A201	BUILDING ELEVATIONS		
A501	INTERIOR DETAILS		
A502	EXTERIOR DETAILS		

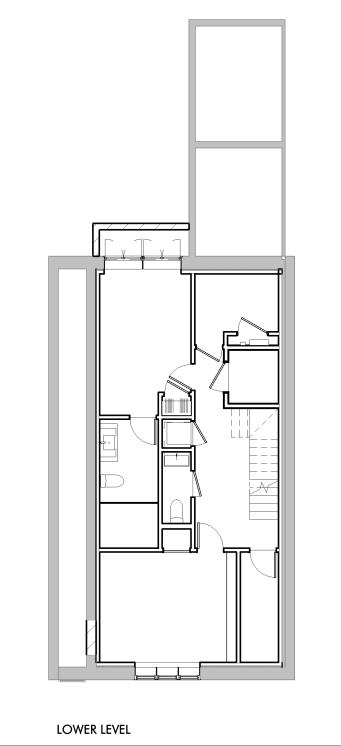

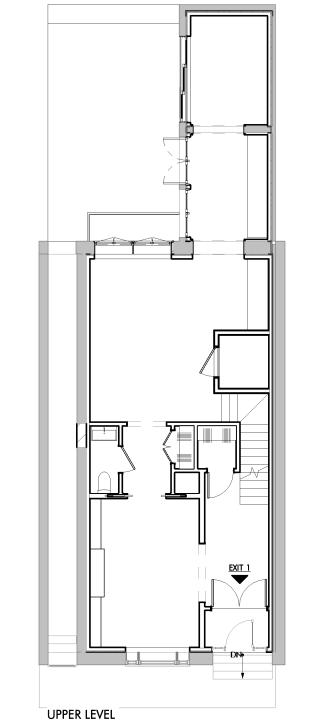


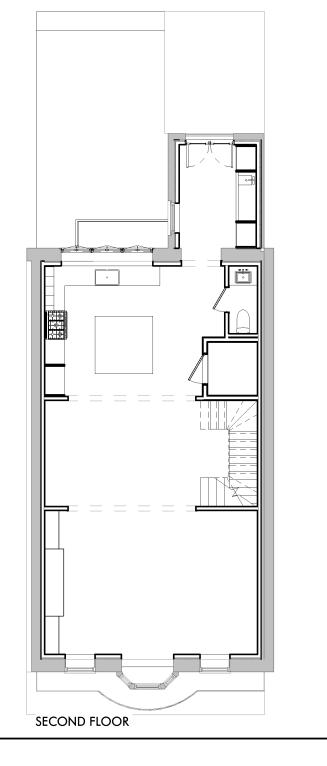

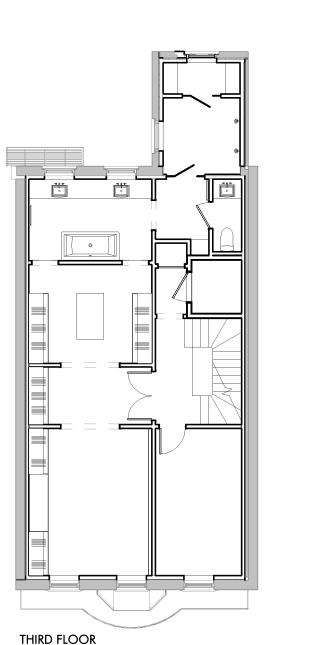


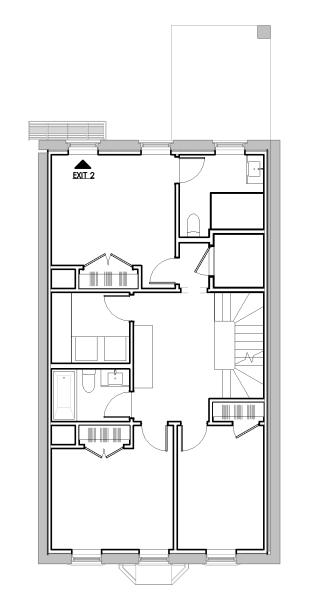

FOURTH FLOOR

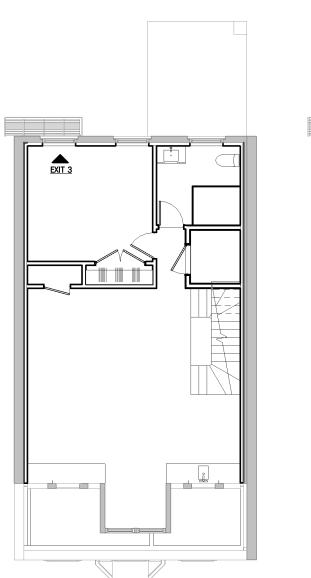

FIFTH FLOOR

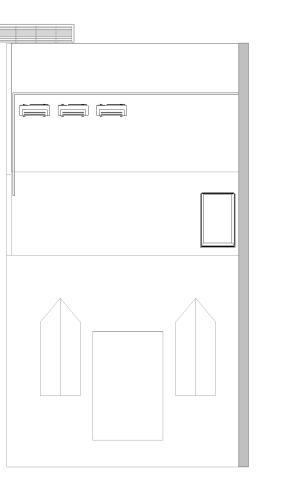

ROOF LEVEL

DRAWING INFORMATION ISSUE: ISSUED FOR CONSTRUCTION

REVISIONS

MARK ISSUE DATE

BOSTON, MA 02118
O: 617.766.8330
www.embarcdesign.com

92 HIGH STREET, SUITE 22 MEDFORD, MA 02155

CONSULTANTS

7 CHESTNUT STREET LLC

ONSTRUCTION

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OWNER

AUGUST 30, 2022 PROJECT #: 22010 SCALE: As indicated

DRAWING TITLE COVER

DRAWING NUMBER copyright: EMBARC DESIGN, LLC

ROUGH OPENING SCHEDULE

SEE LANDSCAPE DRAWINGS

TONGUE AND GROOVE

UNLESS OTHERWISE NOTED

W/O WITHOUT

WATERPROOFING MEMBRANE

CODE SUMMARY

Building Overview: The building is an existing five-story residential building. No Change of us or occupancy classification. Proposed work to include (1) proposed dwelling unit, mechanical headhouse, exterior restoration.

Only the exterior brick walls and roofs will be retained. The existing wood interior framing and all other infrastructure is to be

The building is to be fully sprinklered per NFPA 13.

Executive Summary

This report is based on the IBC 2015, the IEBC 2015, MA amendments; collectively the 9th Edition of 780 CMR.

Using the Work Area Method, this is a Level 3 project.

APPLICABLE CODES

Code Type Applicable Code

(Model Code Basis)

Building 780 CMR: Massachusetts Building Code (9th Edition)
(2015 International Building Code, amended)
(2015 International Existing Building Code, amended)

Energy 2015 International Energy Conservation Code, amended

Fire 527 CMR: Massachusetts Fire Prevention Regulations

(2012 NFPA-1, amended) NFPA 10 for fire extinguisher placement

Accessibility

Accessibility

NFPA 13 for fire protection systems

521 CMR: Massachusetts Architectural Access Board Regulations (2006)

ADA: Americans With Disabilities Act (ADAAG 2010)

Electrical 527 CMR 12.00: Massachusetts Electrical Code (2017 National Electrical Code, amended)

Mechanical 2015 International Mechanical Code
Plumbing 248 CMR 10.00: Massachusetts Plumbing Code
Sanitary 105 CMR 410: Massachusetts State Sanitary Code

Existing Building Overview

Existing Occupancy: Group R-3 (one- or two- family residential), 1 unit Proposed Occupancy: Group R-3 (one- or two- family residential), 1 unit Height and Area: 5 stories; 62'-8"; 6,359 ft²

Minimum Construction Type: Type IIIB (Fully Sprinklered)

Project Data

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SECOND	0	1174
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Work Area Compliance Method

The premise behind the three levels of work is, besides requiring that all new equipment and systems meet the code for new construction, that additional building improvements are required above and beyond the scope of work otherwise proposed.

Alterations -- Level 1: Level 1 alterations covers removal and replacement of existing materials, elements, equipment or fixtures using like materials that serve the same purpose.

Alterations – Level 2: Level 2 alterations include the reconfiguration of space, the addition or elimination of any door or window, the reconfiguration of any system, or the installation of any additional equipment.

Alterations – Level 3: Level 3 alterations apply where the work area exceeds 50 percent of the aggregate area

Analysis: The project is Level 3 project, which requires full compliance with all provisions for Level 1, Level 2 and Level 3. The provisions of Chapters 6, 7, and 8 all apply for this project.

New Construction

of the building.

Level 1, IEBC 602.4: All new work shall comply with materials and methods requirements in the IBC, IECC, and IMC, as applicable...

Analysis: The new fixtures, finishes, and replacement equipment must meet the provisions of the code for new construction. The provisions of Level 1 will be met.

Level 2, IEBC 701.3: All new construction elements, components, systems and spaces shall comply with the requirements of the IBC.

Analysis: Fixtures, finishes, and replacement equipment and materials must meet the provisions of the code for new construction. In the event the provisions for new construction cannot be met, Compliance Alternatives may be proposed.

Height and Area Limitations

Since the interior structure is new, compliance with current height and area limitations is required.

Energy Code SECTION R402: RESIDENTIAL BUILDING ENVELOPE REQUIREMENTS (TABLE C402.1.2)

BUILDING ELEMENT	CLIMATE ZONE 5A (A - MOIST) - INSULATION R-VALUES		
CEILING	R-49		
WOOD FRAME WALL	R-20 OR R-13 cavity +R-5ci		
MASS WALLS	R-13/17 ^a		
FLOORS	R-30 ^b		
ROOF/CEILINGS	R-49 (min. R-30 allowed at 500sf or 20% of total insulated ceiling area - R402.2.2)		
BASEMENT WALL	R-15/19 ^c		
SLABd	R-10 AND 2FT DEEP (when slab surface is less than 12" below grade - R402.2.10)		
CRAWL SPACE WALL	R-15/19 ^c		

- a. R-13ci on interior or exterior of the home or R-17 cavity insulation on the interior of the basement wall
- Alternatively, insulation sufficient to fill the framing cavity and providing not less than an R-value of R-19.
 R-15ci on entieror or exterior of the home or R-19 cavity insulation on the interior of the basement wall. Alternatively, compliance shall be
- R-15ci on entieror or exterior of the home or R-19 cavity insulation on the interior of the basement wall. Alternatively, compliance shall be R-5ci on the interior or exterior of the home plus R-13 cavity insulation on interior the basement wall.
- R-5 insulation shall be provided under full salb area of a heated slab in addition of the ra'd slab edge insulation R-value for slabs, as indicated in table. The slab edge insulation for heated slabs shall not be required to extend below the slab.

Primary Structural Frame Fire Resistance Ratings: The table shown below summarizes the requirements for Type IIIB construction. This table is based upon 780 CMR Table 601.

Building Element	IBC Type IIIB (Hours)	Analysis: The fire separation distance is 20 feet o		
Structural frame		greater on the front and rear exterior walls. The		
Including columns, girders, trusses	OB	allowed percentage of exterior wall openings is		
Bearing walls		unlimited and front and rear walls do not need to		
Exterior	2 ^{A, B}	be rated unless as Type IIIB if loadbearing. An		
Bearing walls		exposed exterior wall will need to be fire resistan		
Interior	0	rated for one hour for exposure from both sides.		
Non-Bearing Walls and Partitions		All exterior walls must be non-combustible in Typ		
Exterior	1 A	IIIB; fire retardant wood is permitted.		
Non-Bearing Walls and Partitions		TI		
Interior	0	The party walls (780 CMR 706.1.1) are consider		
Floor Construction		a shared structural wall between adjacent dwellir		
Including supporting beams and joists	OB	and shall be constructed as a 3hr rated fire wall		
Roof Construction		a R-3, IIIB building.		
Including supporting beams and joists	0			

A. Not less than rating based on fire separation distance (addressed later in this report)
 B. Not less than rating of structure supported

Fire resistance Assemblies: The table shown below summarizes the fire resistance ratings for various wall types in the building and their opening protectives:

Building Element	Wall Type	Fire Resistance Rating (Hours)	Opening Protection Rating
Shafts, Stair and Hoistway Enclosures Fire Barr	ier 2 (1ª)	<u> </u>	90 minutes (60°)
Dwelling Unit Separations, Type IIIB Fire Part			20 ^b
Non-dwelling/Dwelling Unit Separations	Fire Partition	1	45 minutes
Common Area Corridors serving sleeping			
rooms or dwelling units	Fire partition	0.50 ^c	20 ^{ab} minutes
Electrical/Telecom Closets			
Electrical Rooms with xfmr>112.5 kVa	Fire Barrier	1	60 minutes
Emergency Electrical Rooms	Fire Barrier	2	90 minutes
Transformer Vault	Fire Barrier	3	180 or 2@90 minutes
Fire Pump Room	Fire Barrier	2	90 minutes
Elevator Machine Room	Fire Barrier	2	90 minutes
Mechanical Rooms	Referen	ce Table 509 for Incide	ental Uses

a. If connecting 3 stories or less; but not less than the rating of the building floor.b. Doors must be smoke and draft control doors (780 CMR 716.5.3)

c. Fire resisstance rated supporting construction is not required but the floor slab is required to have a 30 min rating per 780 CMR 712.3 Exception.

780 CMR 420.2 Separation Walls. Walls separating dwelling units in the same building, walls separating sleeping units in the same building and walls separating dwelling or sleeping units from other occupancies contiguous to them in the same building shall be constructed as fire partitions in accordance with Section 708.

709.3 Fire-resistance rating. Fire Partitions shall have a fire-resistance rating of not less than 1 hour. Exception: Dwelling unit and sleeping unit separations in buildings of Type IIB, IIIB and VB construction shall have fire-resistance ratings of not less than 0.5 hour in buildings equipped throughout with an automatic sprinkler system in accordance with Section 903.3.1.1.

Analysis: Walls separating each unit require 0.5 hour fire resistant rating for Type IIIB. Walls separating units from other common use spaces, for example the entry lobby, require a 1 hour rating.

Means of Egress

The means of egress will be via the existing interior stair and the existing exterior fire balcony.

780 CMR 51.00

R311.1 Means of Egress. Dwelling units shall be provided with a primary and secondary means of egress in accordance with this section. Each means of egress shall provide a continuous and unobstructed path of vertical and horizontal egress travel from all portions of the dwelling to the egress doors. The primary means of egress shall not require travel through a garage but the secondary means of egress may. The required egress doors shall open directly into a public way or to a yard or court that opens to a public way.

1. In multi-level dwellings, including but not limited to townhouses, split-level and raised ranch style layouts, the two separate egress doors may be located on different levels.

Analysis: The egress capacity and number of provided exits is compliant.



▼ FLOOR TYPE - C ▼

EMBA

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NØ. 20350
BOSTON

DRAWING INFORMATION

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DATE: AUGUST 30, 2022

PROJECT #: 22010

1/4" = 1'-0"


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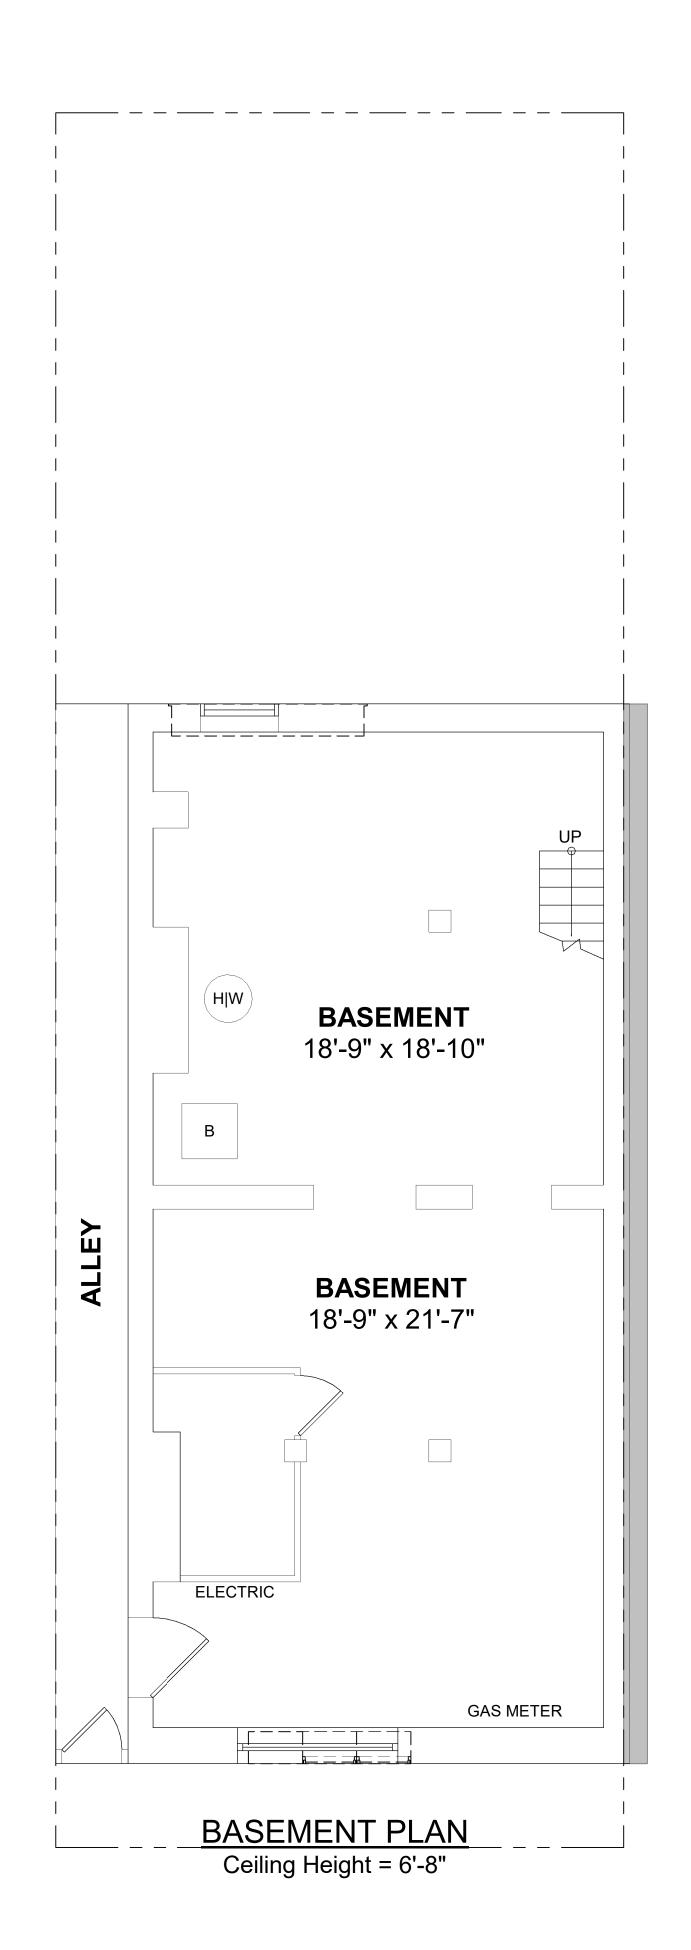
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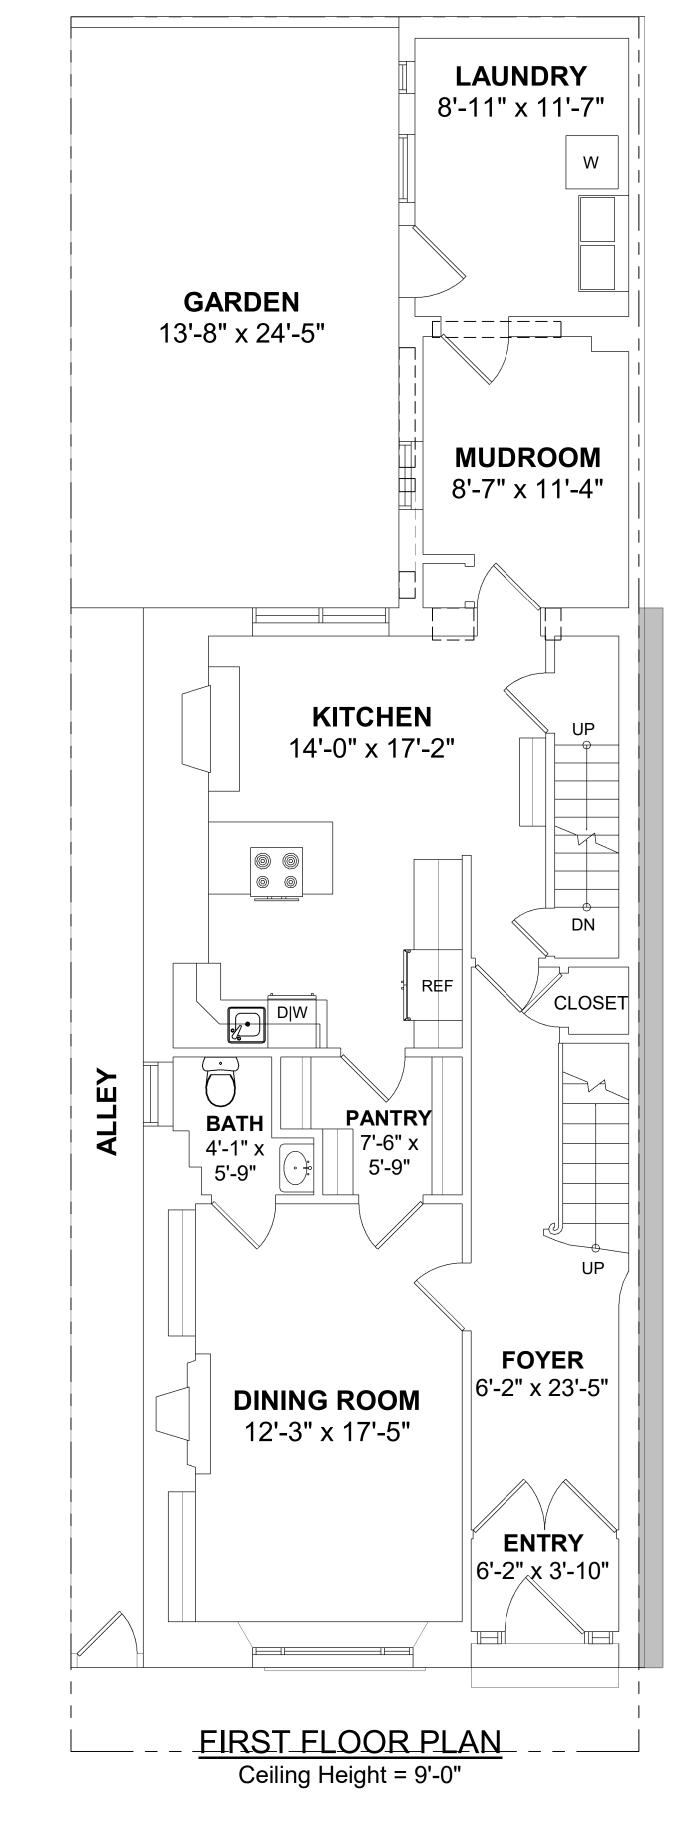
AUGUST 30, 2022 PROJECT #: 22010 1 1/2" = 1'-0"


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DRAWING NUMBER


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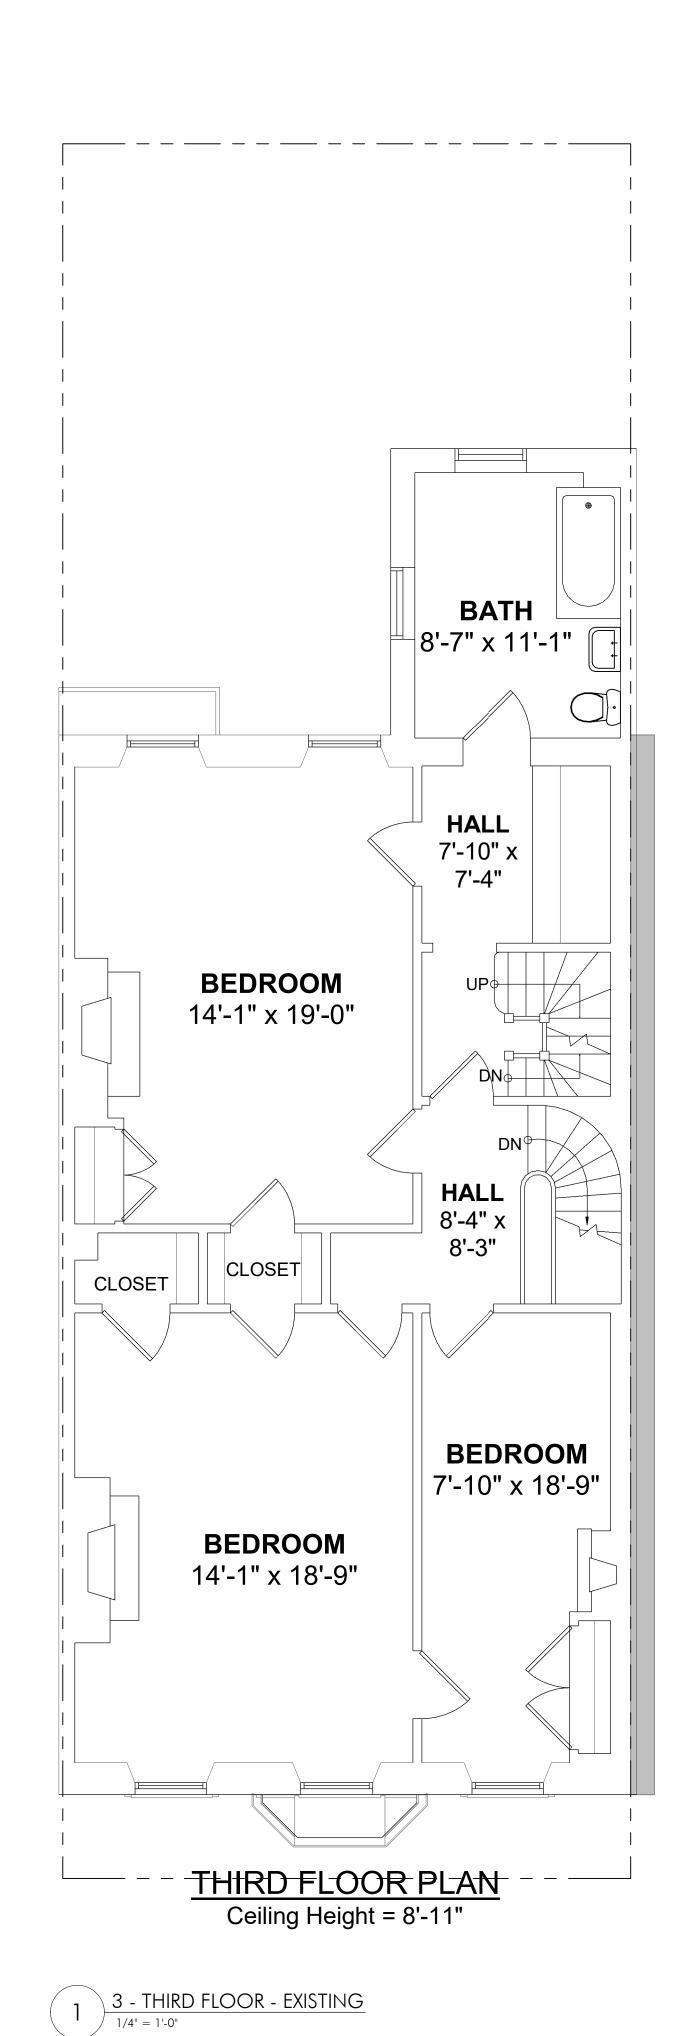





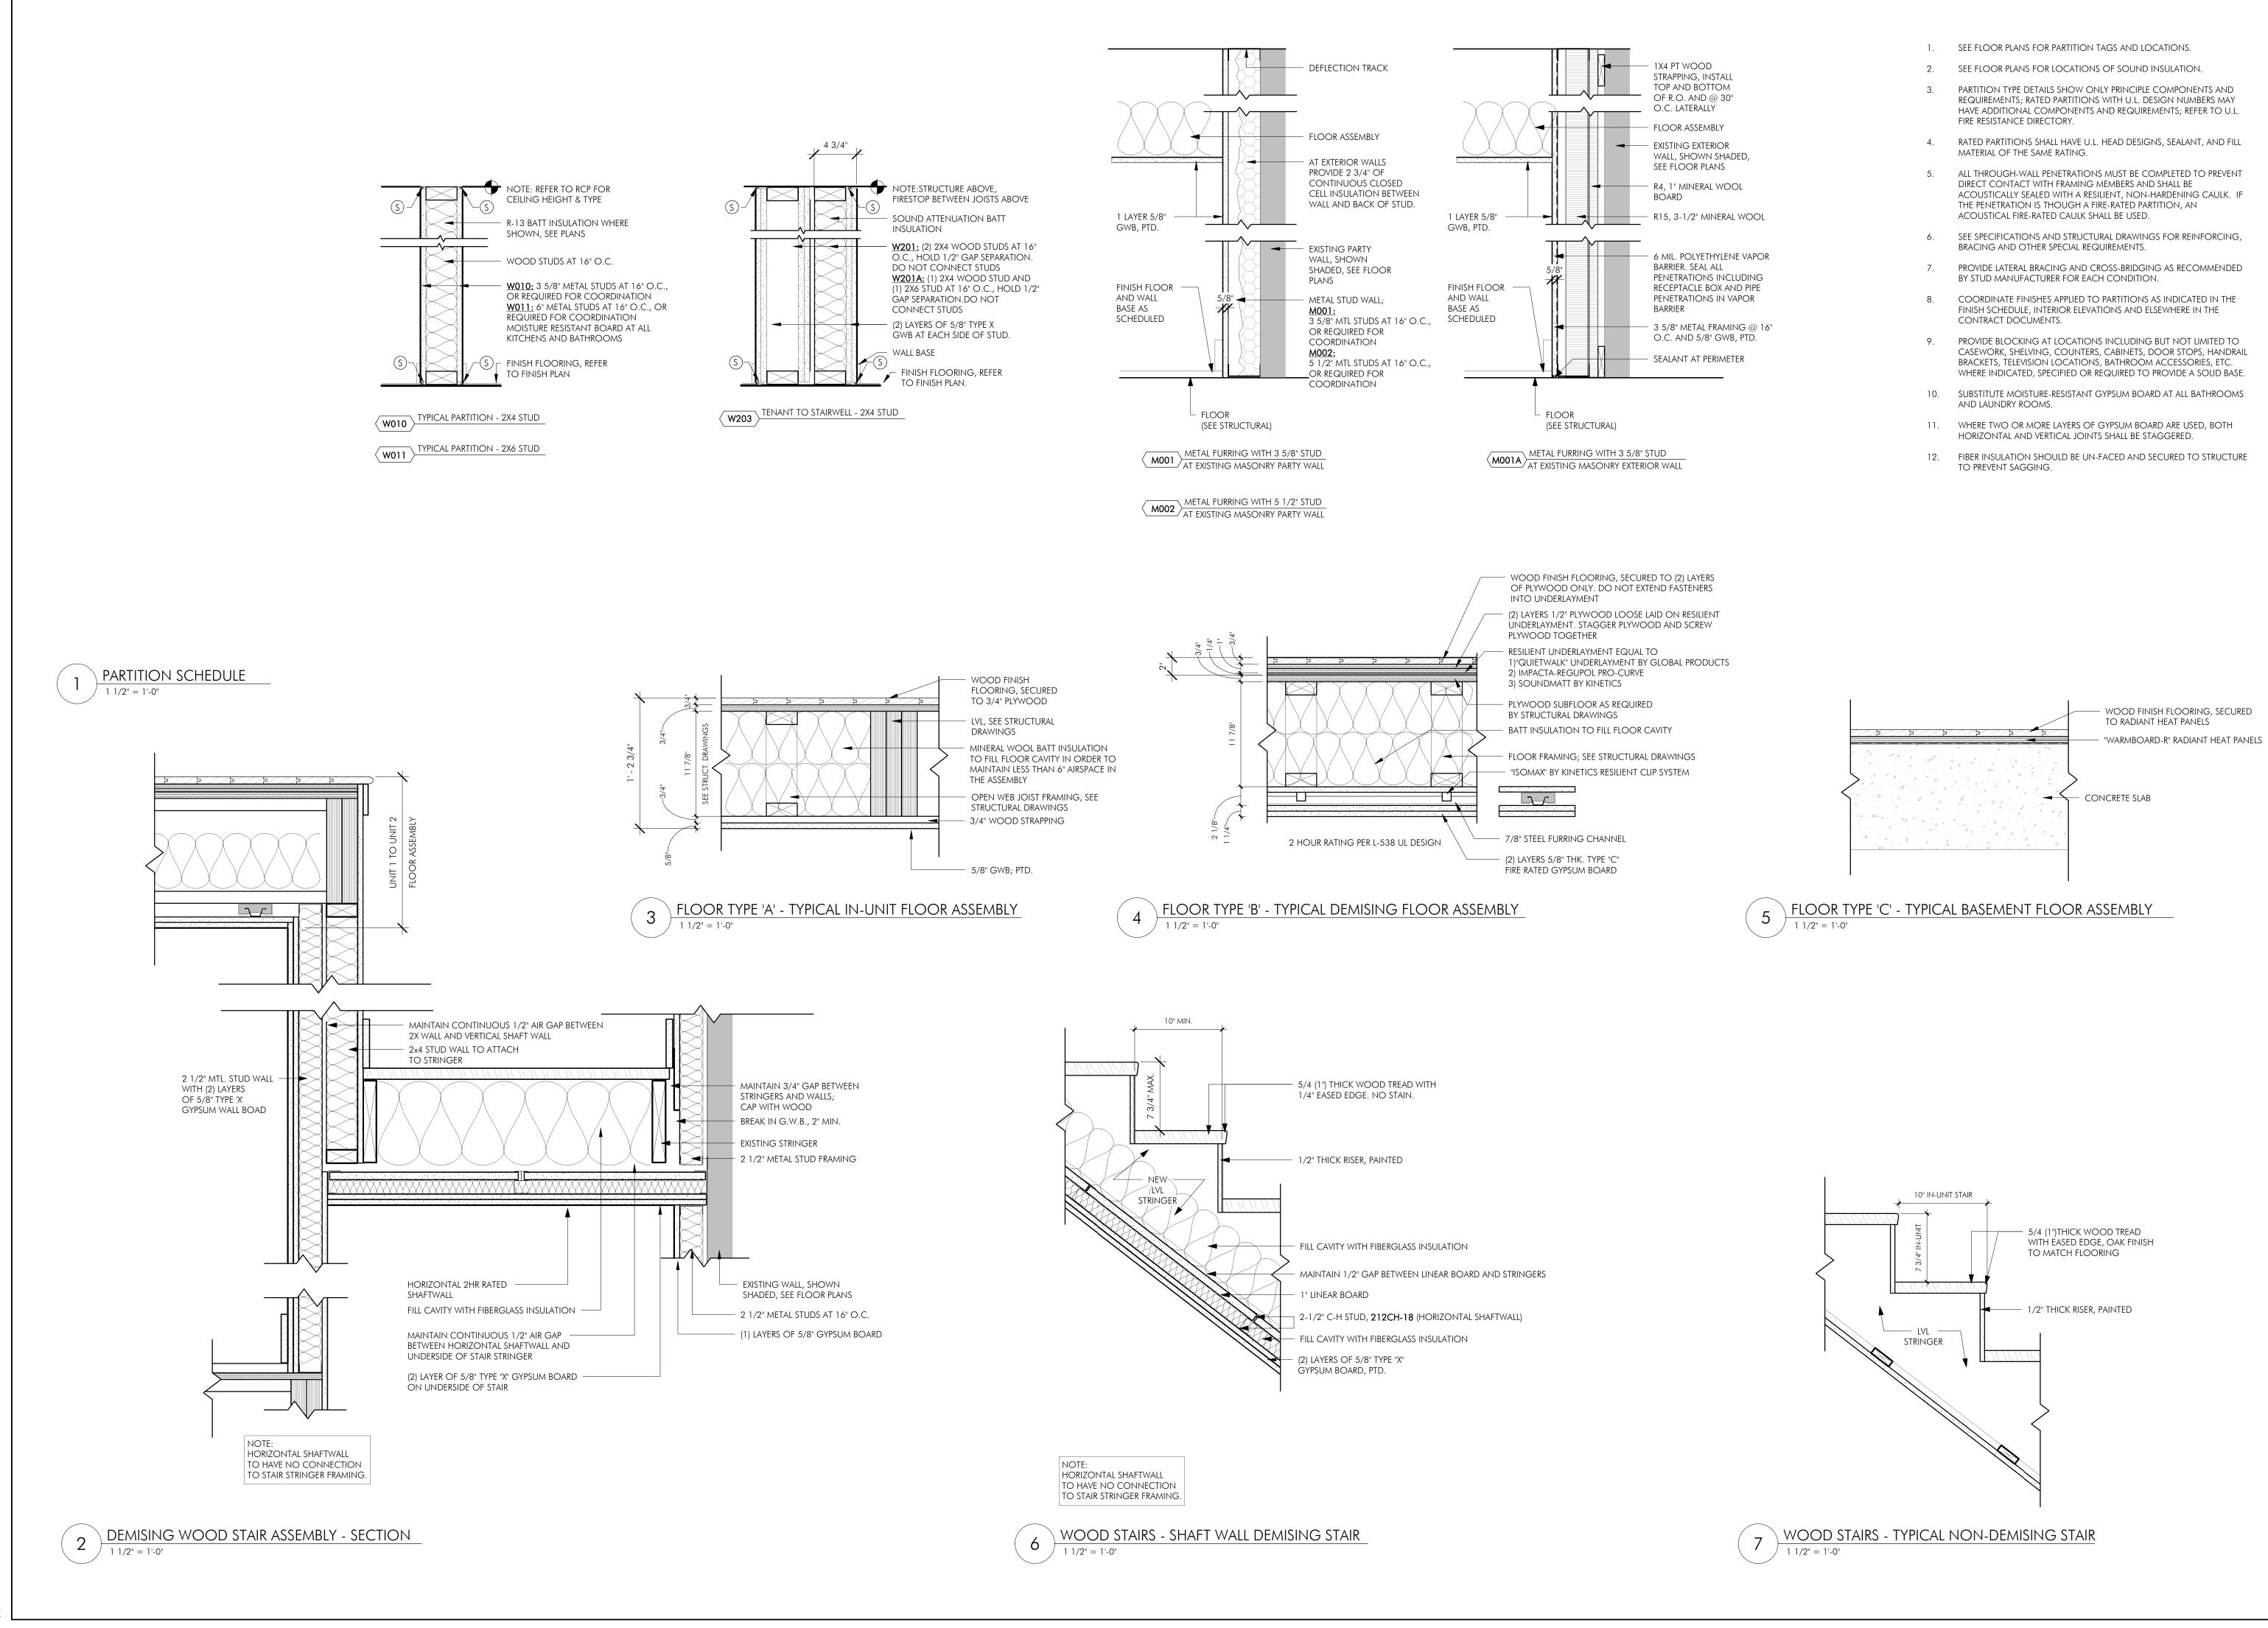


2 1 - FIRST FLOOR - EXISTING

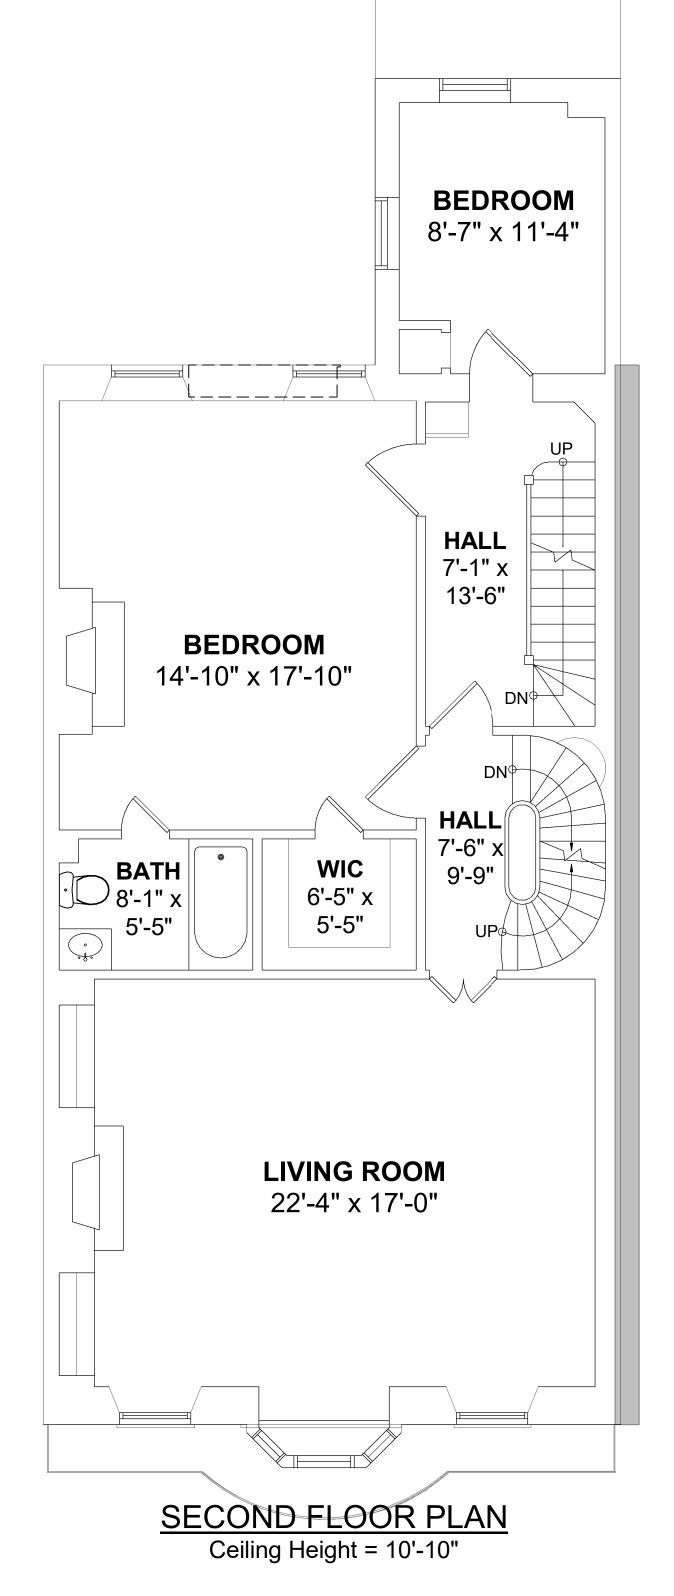

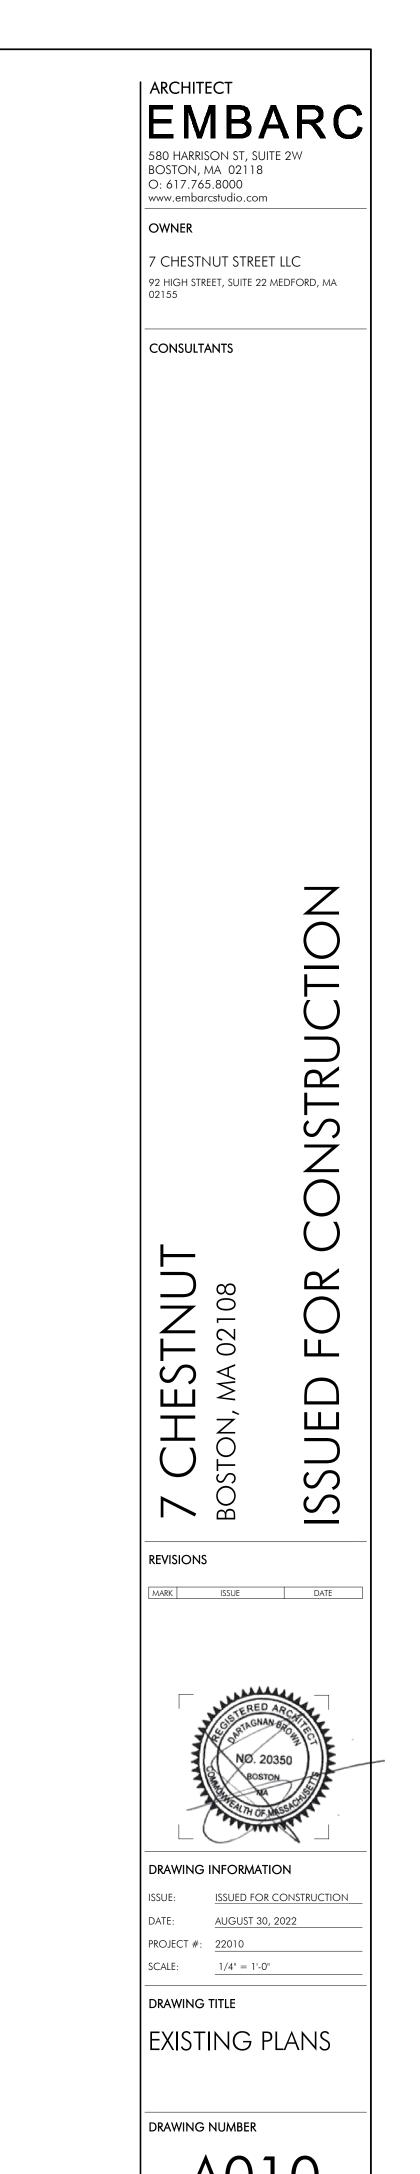

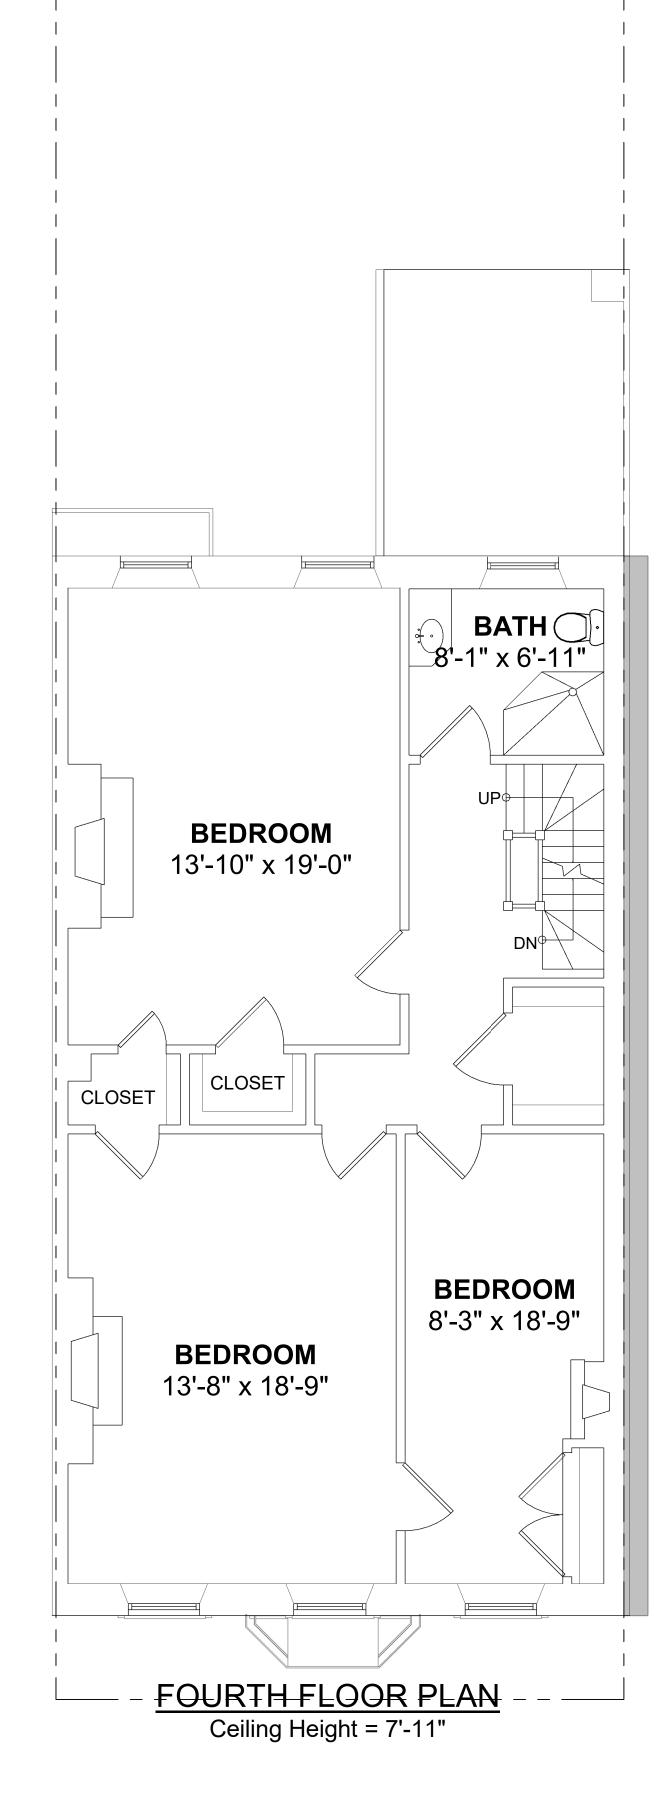

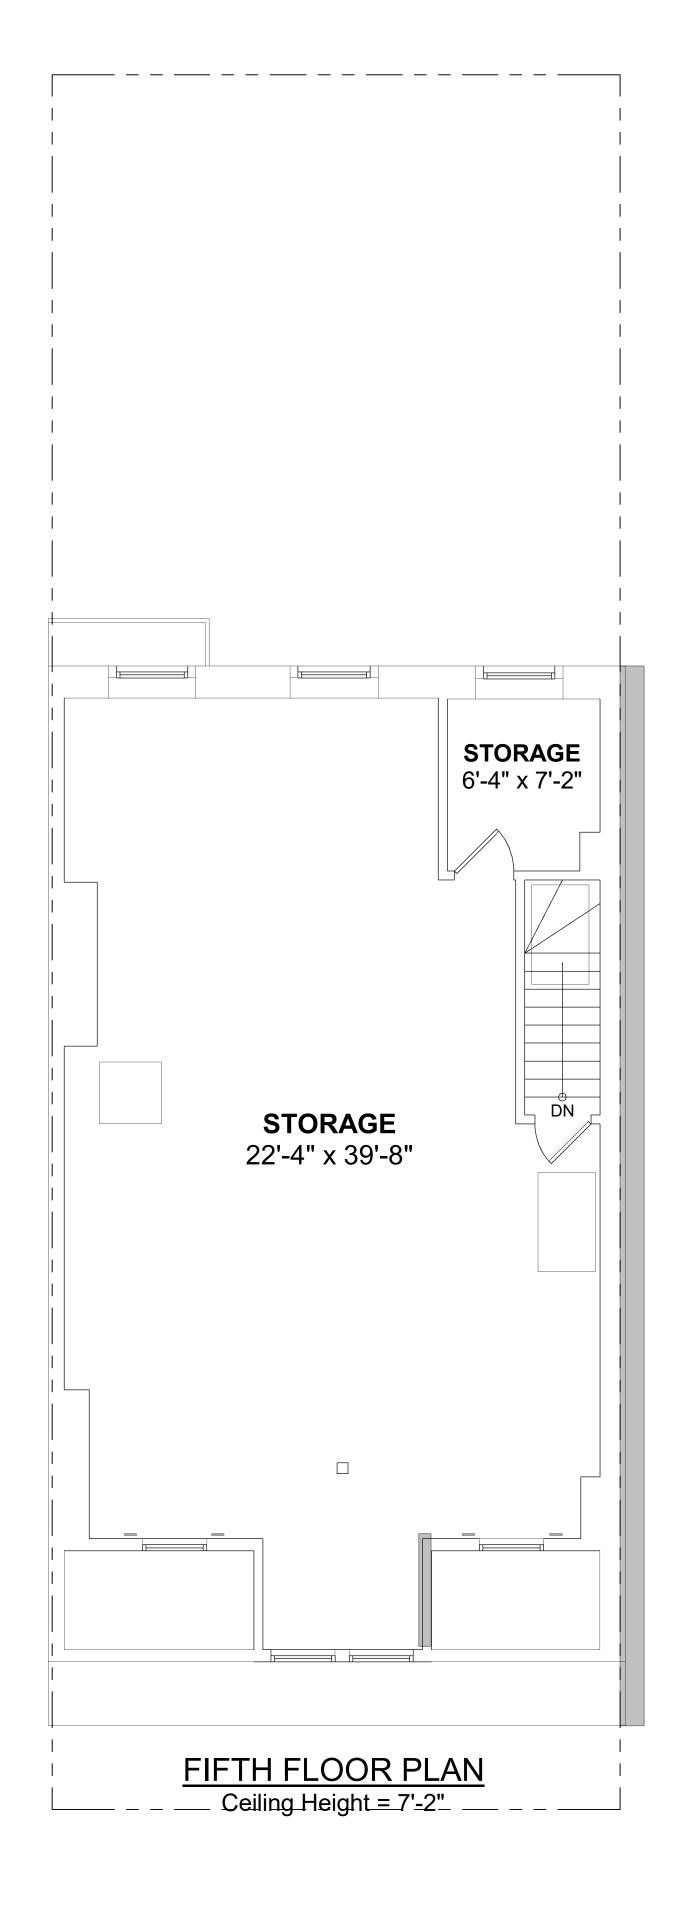

3 5 - FIFTH FLOOR - EXISTING

| ARCHITECT **EMBARC** 580 HARRISON ST, SUITE 2W BOSTON, MA 02118 O: 617.765.8000 www.embarcstudio.com OWNER 7 CHESTNUT STREET LLC 92 HIGH STREET, SUITE 22 MEDFORD, MA 02155 CONSULTANTS 7 CHESTNUT BOSTON, MA 02108 FOR ISSUED REVISIONS


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DRAWING TITLE EXISTING PLANS


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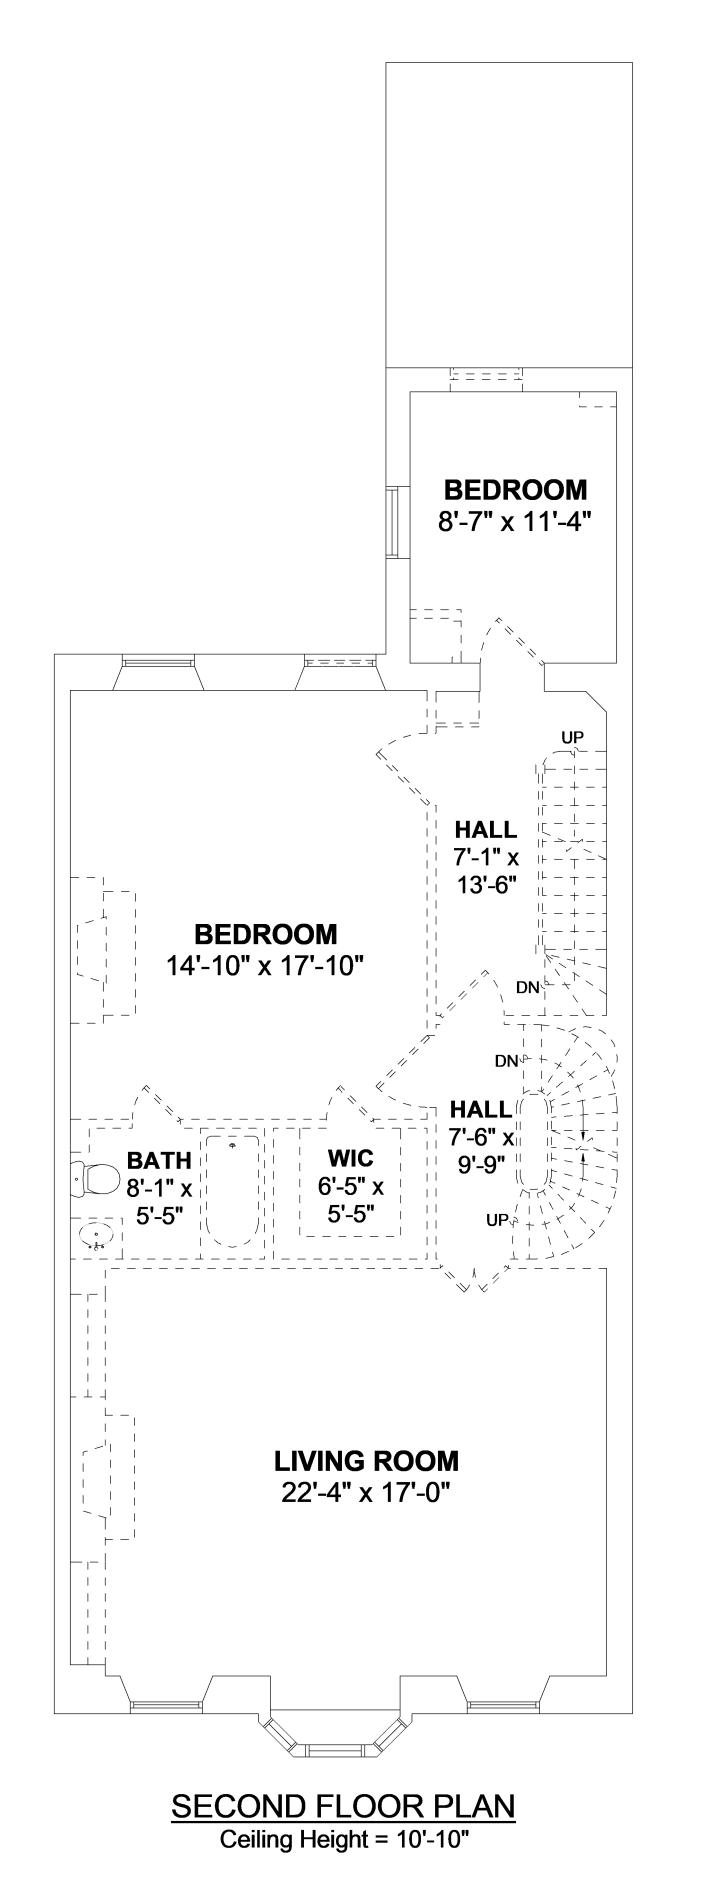
A011



BASEMENT PLAN
Ceiling Height = 6'-8"

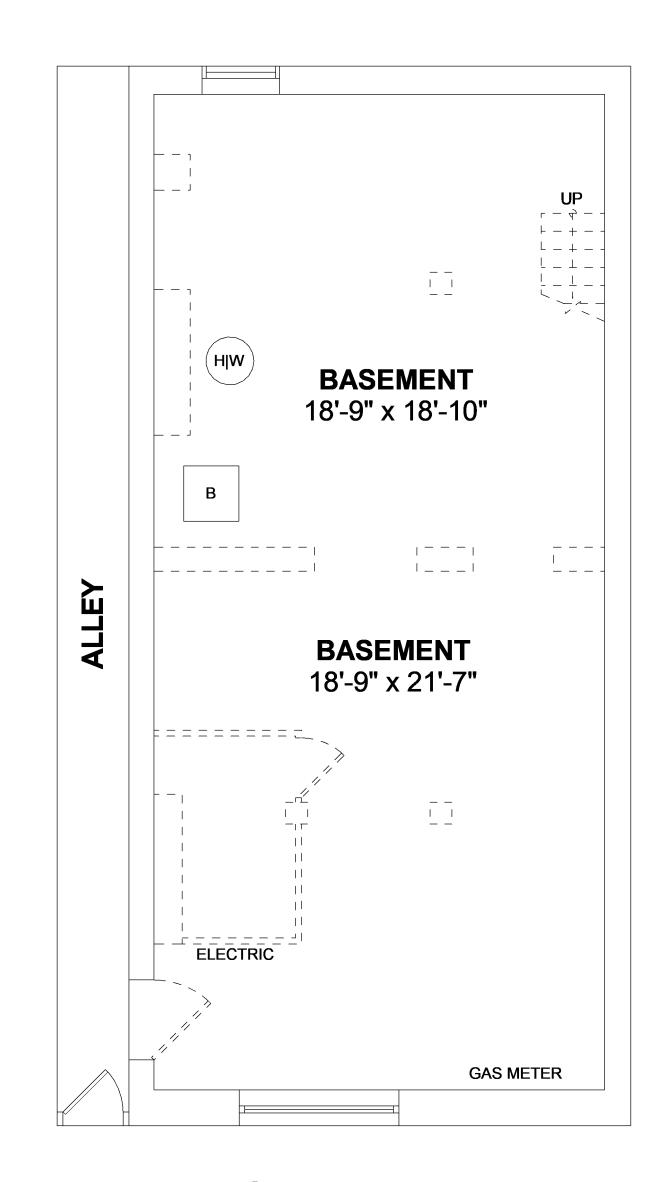

FIRST FLOOR PLAN
Ceiling Height = 9'-0"

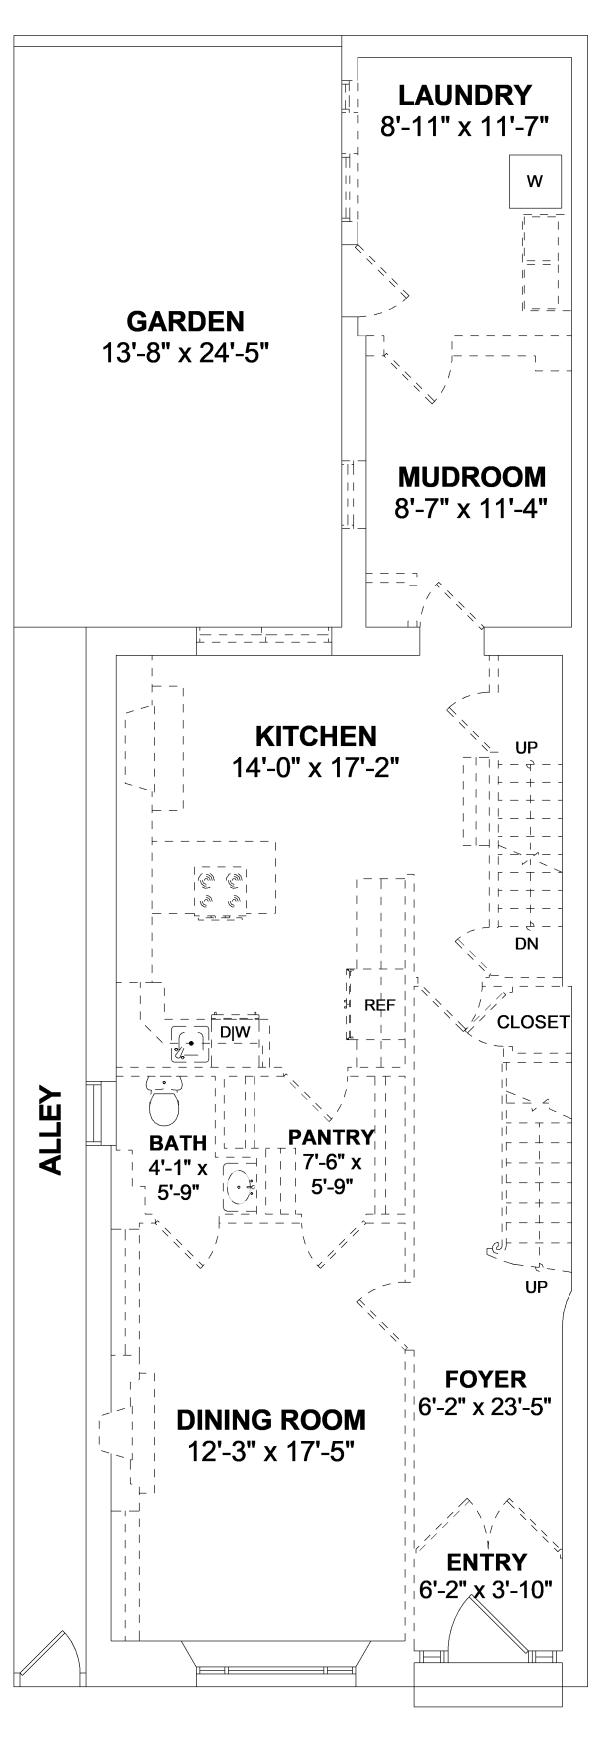

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02155

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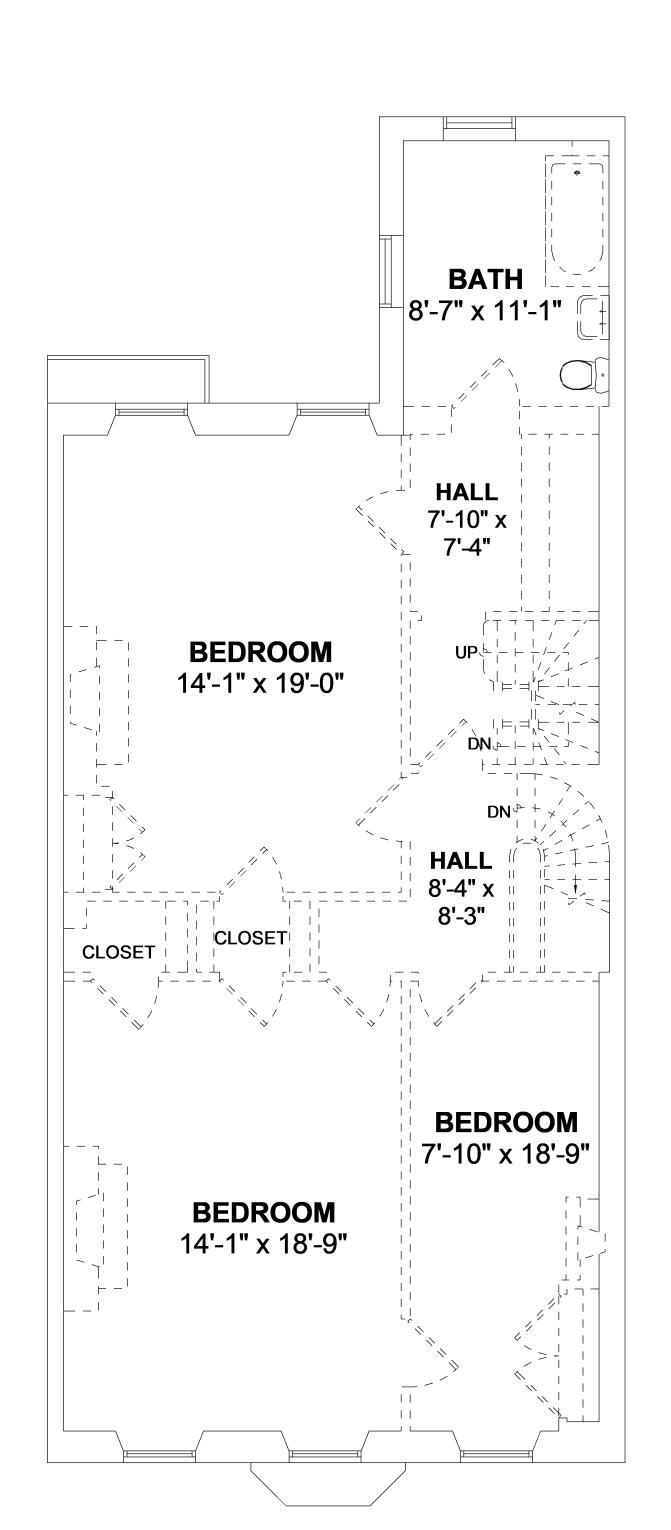
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DEMOLITIC


DEMOLITION PLANS

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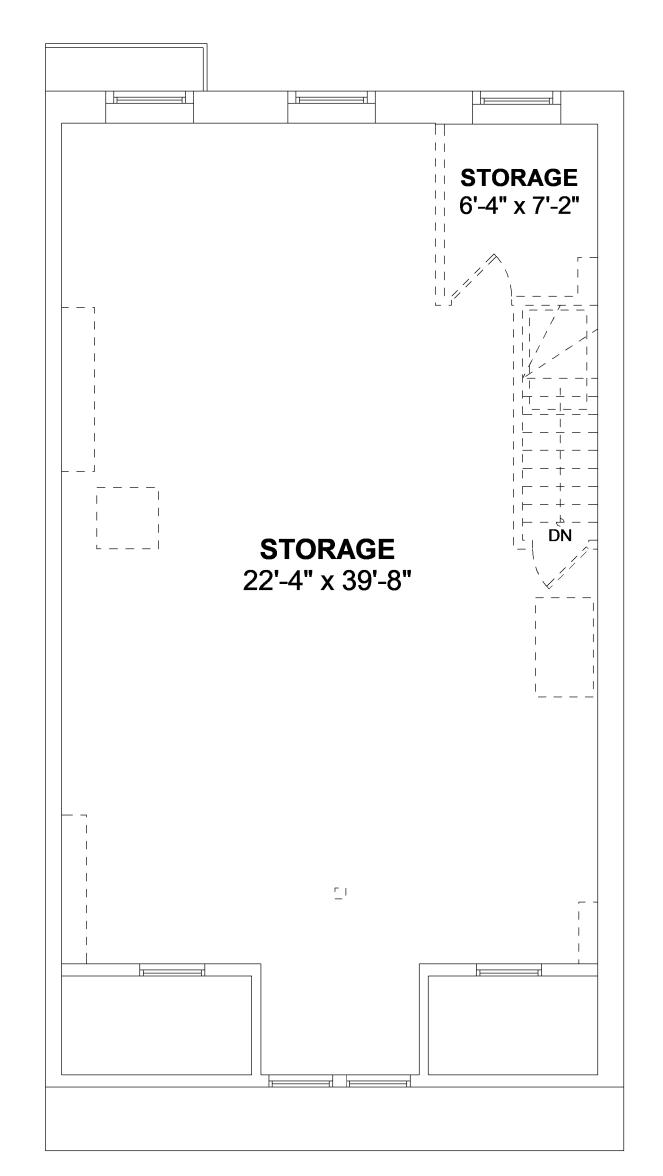
D101



THIRD FLOOR PLAN
Ceiling Height = 8'-11"

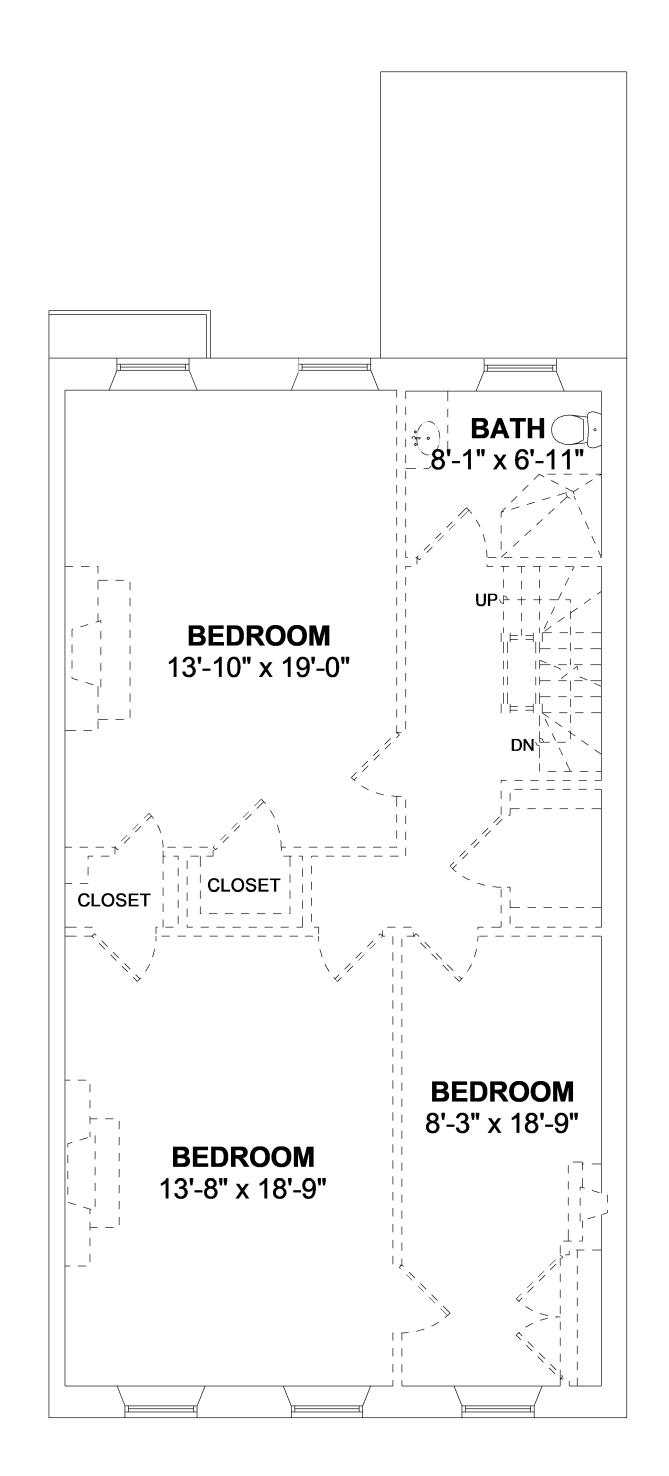

FOURTH FLOOR PLAN
Ceiling Height = 7'-11"



FIFTH FLOOR PLAN
Ceiling Height = 7'-2"

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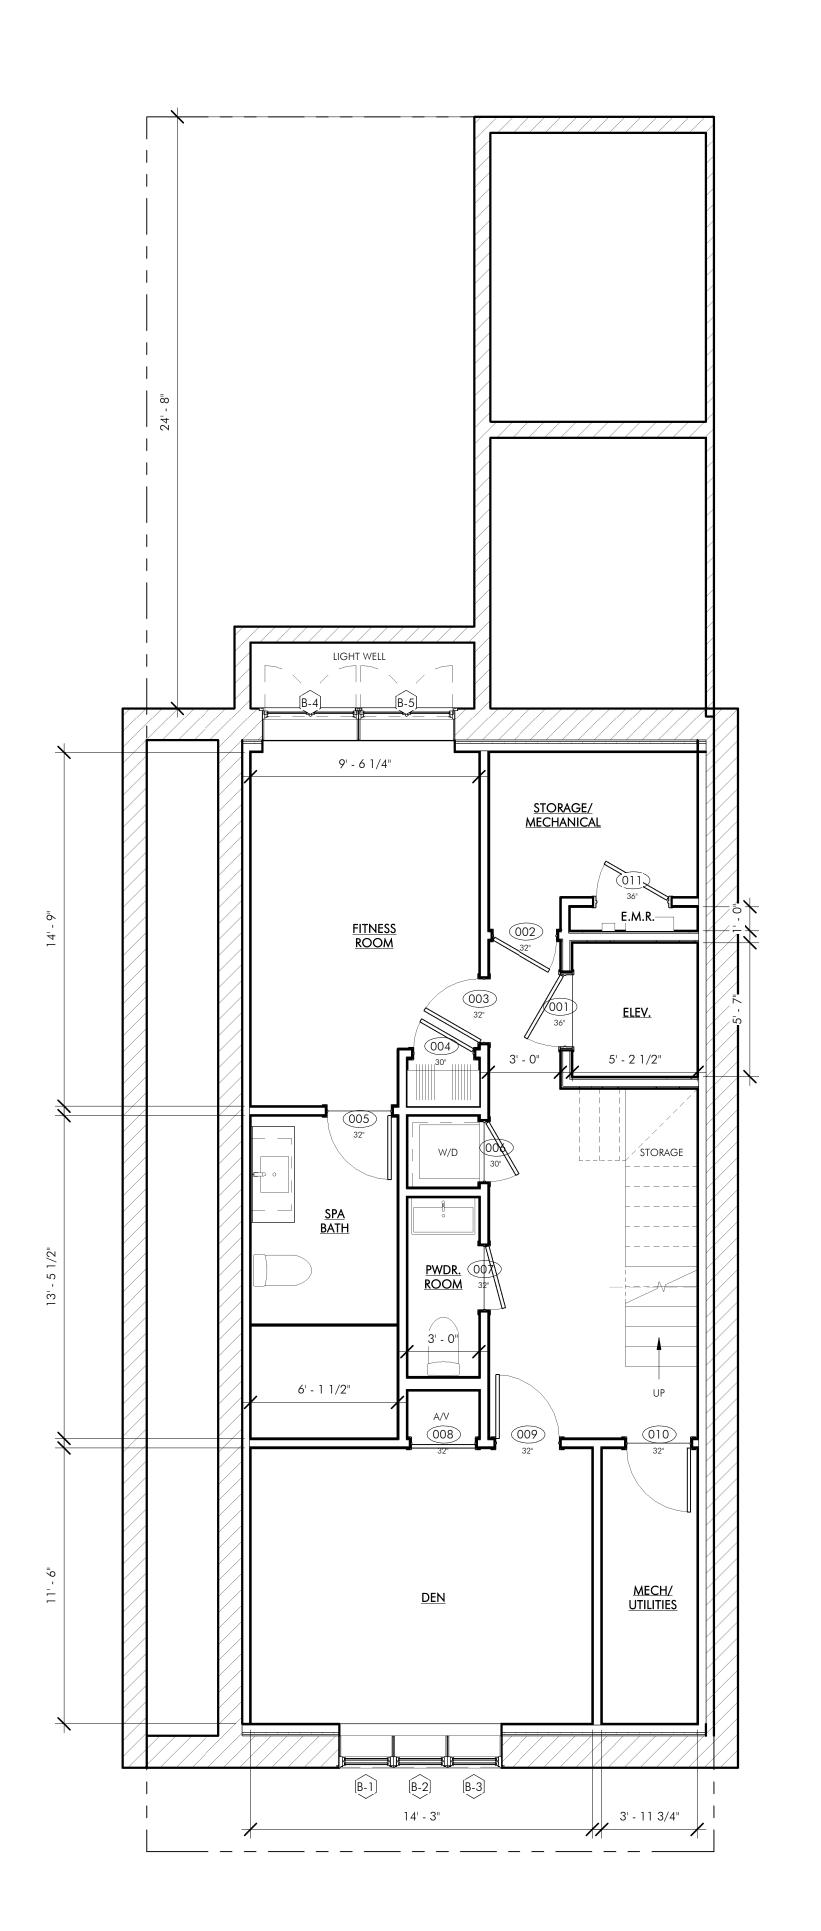
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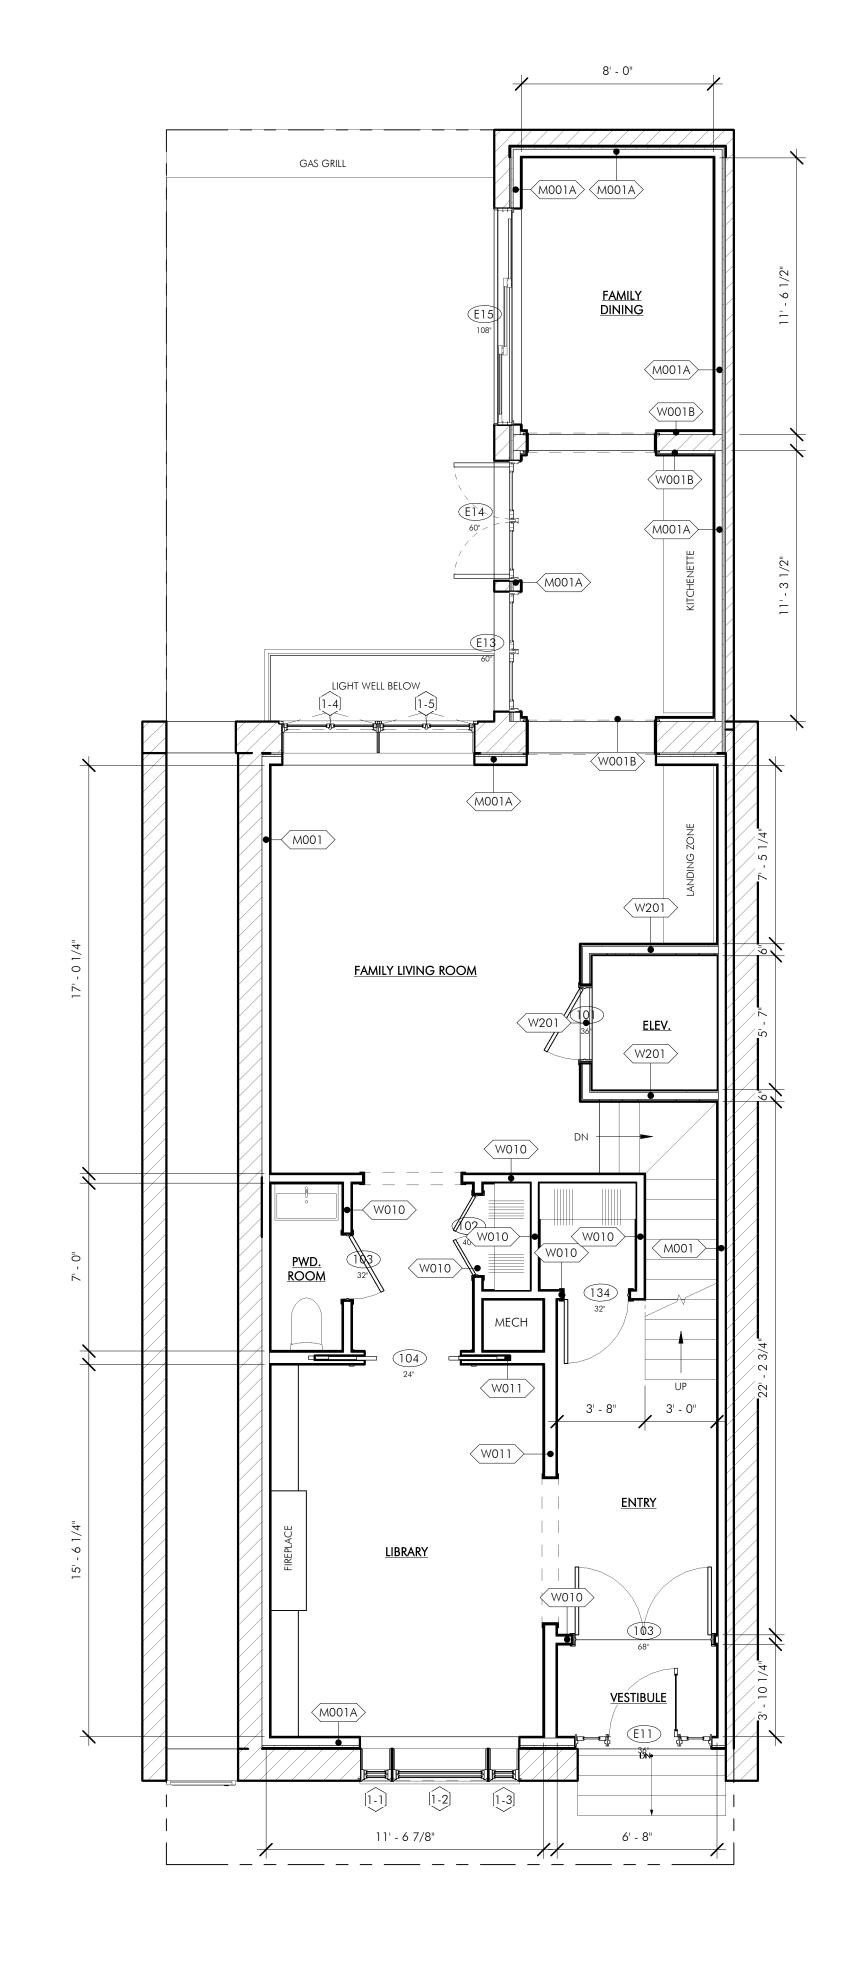
SCALE: 1/4" = 1'-0"

DEMOLITION
PLANS

DRAWING NUMBER

D102







- WHEN SPECIFIC FEATURES OF CONSTRUCTION ARE NOT FULLY SHOWN ON THE DRAWINGS OR CALLED FOR IN THE GENERAL NOTES, THEIR CONSTRUCTION SHALL BE OF THE SAME CHARACTER AS SIMILAR CONDITIONS.
- 2. ALL DIMENSIONS ARE TO BE TAKEN FROM NUMERIC DESIGNATIONS ONLY;

DIMENSIONS ARE NOT TO BE SCALED OFF THE DRAWINGS.

- 3. ALL INTERIOR DIMENSIONS ARE TO FACE OF FINISH UNLESS OTHERWISE NOTED.
- 4. ALL GYPSUM BOARD SURFACES ARE TO BE 5/8" THICK UNLESS OTHERWISE NOTED.
- 5. ALL GYPSUM AND PLASTER FINISHES SHOULD BE SMOOTH, CONTINUOUS, FREE OF IMPERFECTIONS. AND HAVE NO VISIBLE JOINTS.
- 6 PROVIDE GAS, WATER SPIGOT, OUTLET, AND LIGHTING AT ROOF DECKS; FOR LOCATIONS, SEE FLOOR PLANS AND REFLECTED CEILING PLANS.
- 7. ALL CLOSETS SHALL HAVE SHELF AND POLE OR SHELVES AS REQUIRED, UNLESS OTHERWISE NOTED.
- 8. ALL REQUIRED LIFE SAFETY DEVICES, INCLUDING SMOKE & CARBON MONOXIDE DETECTORS, SHALL BE INSTALLED BY THE CONTRACTOR IN COMPLIANCE WITH THE 2015 INTERNATIONAL BUILDING CODE

PLAN NOTES

- 1. ALL DIMENSIONS ARE MEASURED FROM FACE OF EXISTING BRICK TO FINISH FACE OF G.W.B. OR FROM FINISH FACE OF G.W.B. TO FINISH FACE OF G.W.B.
- 2. ALL DOORS ARE 84" TALL UNLESS OTHERWISE NOTED.
- 3. ALL EXISTING PARTY WALLS AND EXTERIOR WALLS TO RECIEVE FURRING WALL TYPE AS INDICATED ON PLANS

MECHANICAL | SECURITY NOTES


- PROVIDE NEST LEARNING THERMOSTAT AT EACH UNIT. (ZONING PER FLOOR LEVEL IN DUPLEX UNITS)
- 2. HEATING AND AIR CONDITIONING IS TO BE PROVIDED BY HIGH VELOCITY FORCED AIR SPACE PAK HIGH VELOCITY AIR CONDITIONING SYSTEMS WITH HYDRONIC HEATING.
- 3. HOT WATER IS TO BE PROVIDED BY A HIGH EFFICIENCY NAVIEN MODULATING CONDENSING COMBINATION HEATING AND HOT WATER SYSTEM OR EQUAL.

ELECTRICAL NOTES

- ELECTRICAL SERVICE POWER IS TO BE EVALUATED FOR MEETING LIGHTING DESIGN AND EQUIPMENT REQUIREMENTS. PROPER POWER LEVEL SHALL BE PROVIDED.
- 2. ALL NEW ELECTRICAL ITEMS ARE TO BE U.L. RATED.
- 3. ALL ELECTRICAL PANELS ARE TO BE RECESSED INTO A WALL WITH A MINIMUM 6"
- STUD DIMENSION. REVIEW FINAL LOCATION WITH ARCHITECT AND OWNER
- 4. ALL DISTRIBUTION PANELS ARE TO BE NEW.5. LIVING AREAS, DINING AREAS, AND ALL BEDROOM ARE TO RECEIVE 3-WIRE
- JUNCTION BOXES.

 6 PROVIDE INTERCOM AND REMOTE ENTRY DOOR ACCESS BY HOUSING DEVICES,
- INC. OR APPROVED EQUAL.7. PROVIDE ELECTRIC HEAT MATS BY NUHEAT OR EQUAL AT ALL BATHROOMS.
- 8. ALL CLOSET LIGHTING IS TO BE L.E.D. OR HIGH EFFICIENCY LIGHTING.
- 9. OUTLETS IN BATHROOMS SHALL HAVE GROUND FAULT INTERCEPTORS.
- 10. ALL SMOKE DETECTORS SHALL RECEIVE THEIR PRIMARY SOURCE OF POWER FROM BUILDING WIRING WITH BATTERY BACK-UP.
- 11. ALL DIMENSIONS FOR THE FOLLOWING ITEMS ARE TO FINISH SURFACES UNLESS OTHERWISE NOTED:
- A. MOUNT ALL OUTLETS, PHONE JACKS, AND TELEVISION CABLE JACKS VERTICALLY AT 18" TO CENTERLINE ABOVE THE FINISH FLOOR UNLESS OTHERWISE NOTED. WHERE BASE AND TRIM IS LARGER THAN 9-1/2" TALL PROVIDE 6" CLEARANCE FROM BOTTOM OF PLATE TO TOP OF BASEBOARD TRIM
- B. MOUNT ALL SWITCHES AT 42" TO CENTERLINE ABOVE FINISH FLOOR UNLESS OTHERWISE NOTED.
 C. VERTICALLY ALIGN SWITCHES AND OUTLETS WHERE POSSIBLE.

FLOOR PLAN LEGEND

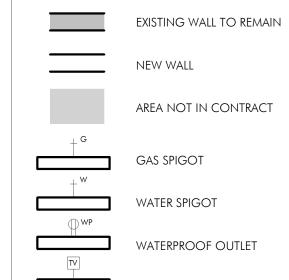

WATERPROOF OUTLET

TV LOCATION

SV

STRUCTURED VIDEO LOCATION

THERMOSTAT LOCATION

NOLSONS

REVISIONS

MARK ISSUE DATE

 Δ

| ARCHITECT

BOSTON, MA 02118

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DRAWING INFORMATION

ISSUE: <u>ISSUED FOR CONSTRUCTION</u>

DATE: <u>AUGUST 30, 2022</u>

PROJECT #: <u>22010</u>

SCALE: 1/4" = 1'-0"

DRAWING TITLE

CONSTRUCTION


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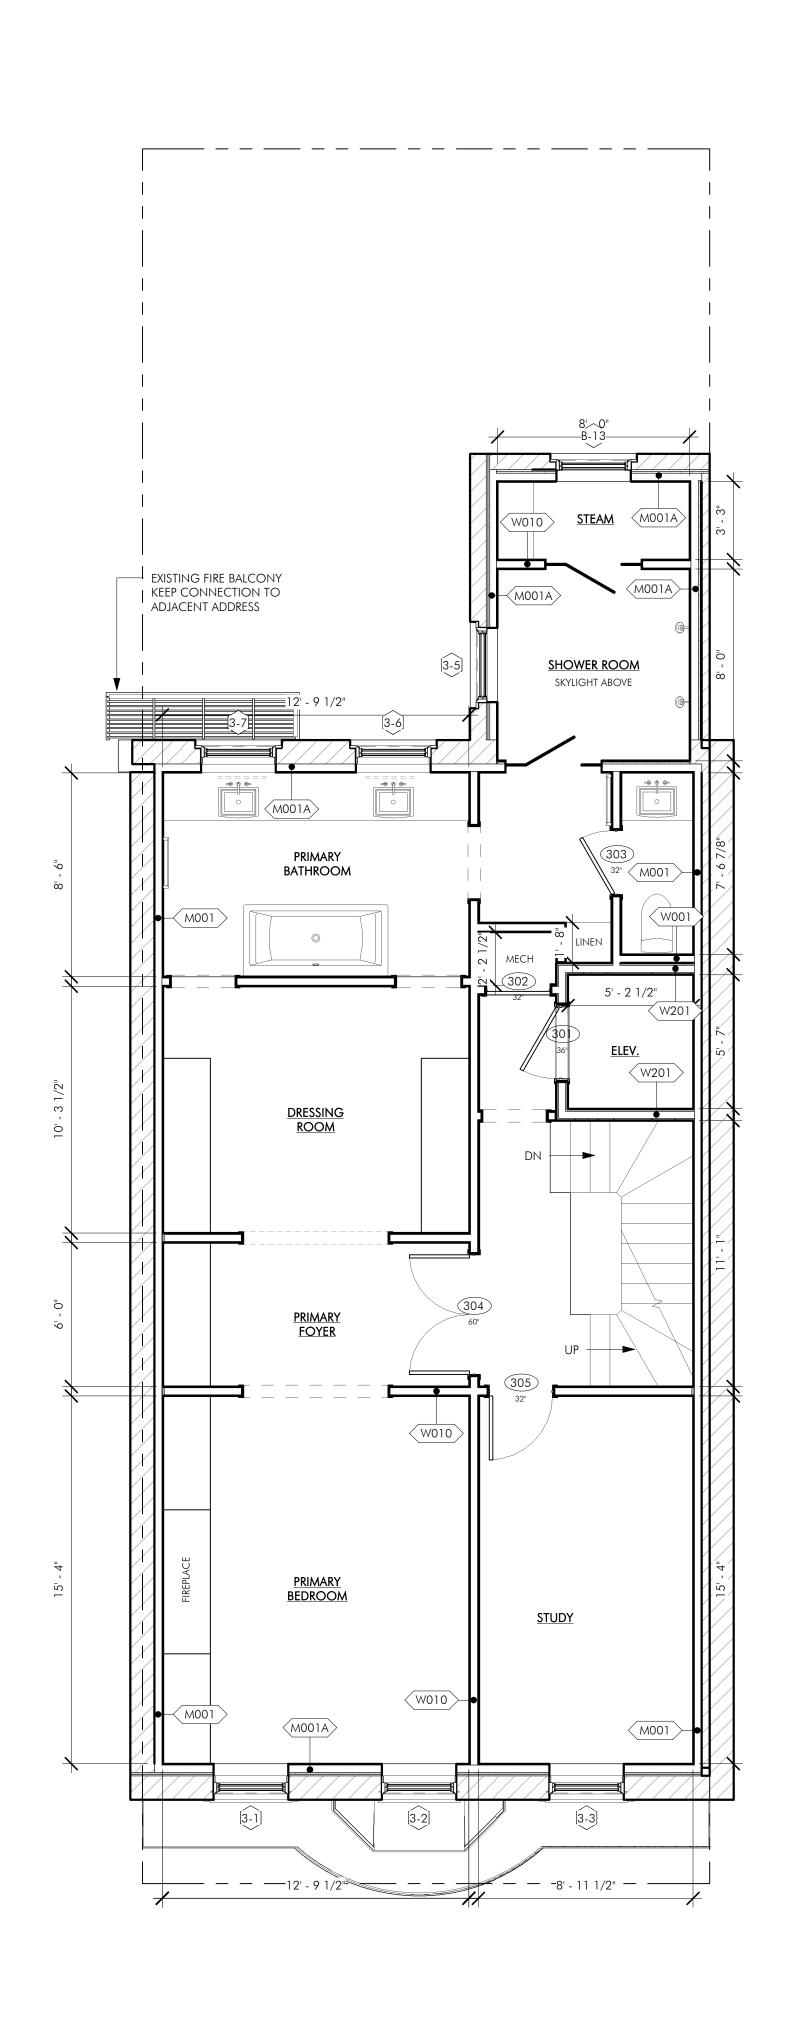
PLANS



0 - BASEMENT (NEW)

2 1 - FIRST FLOOR



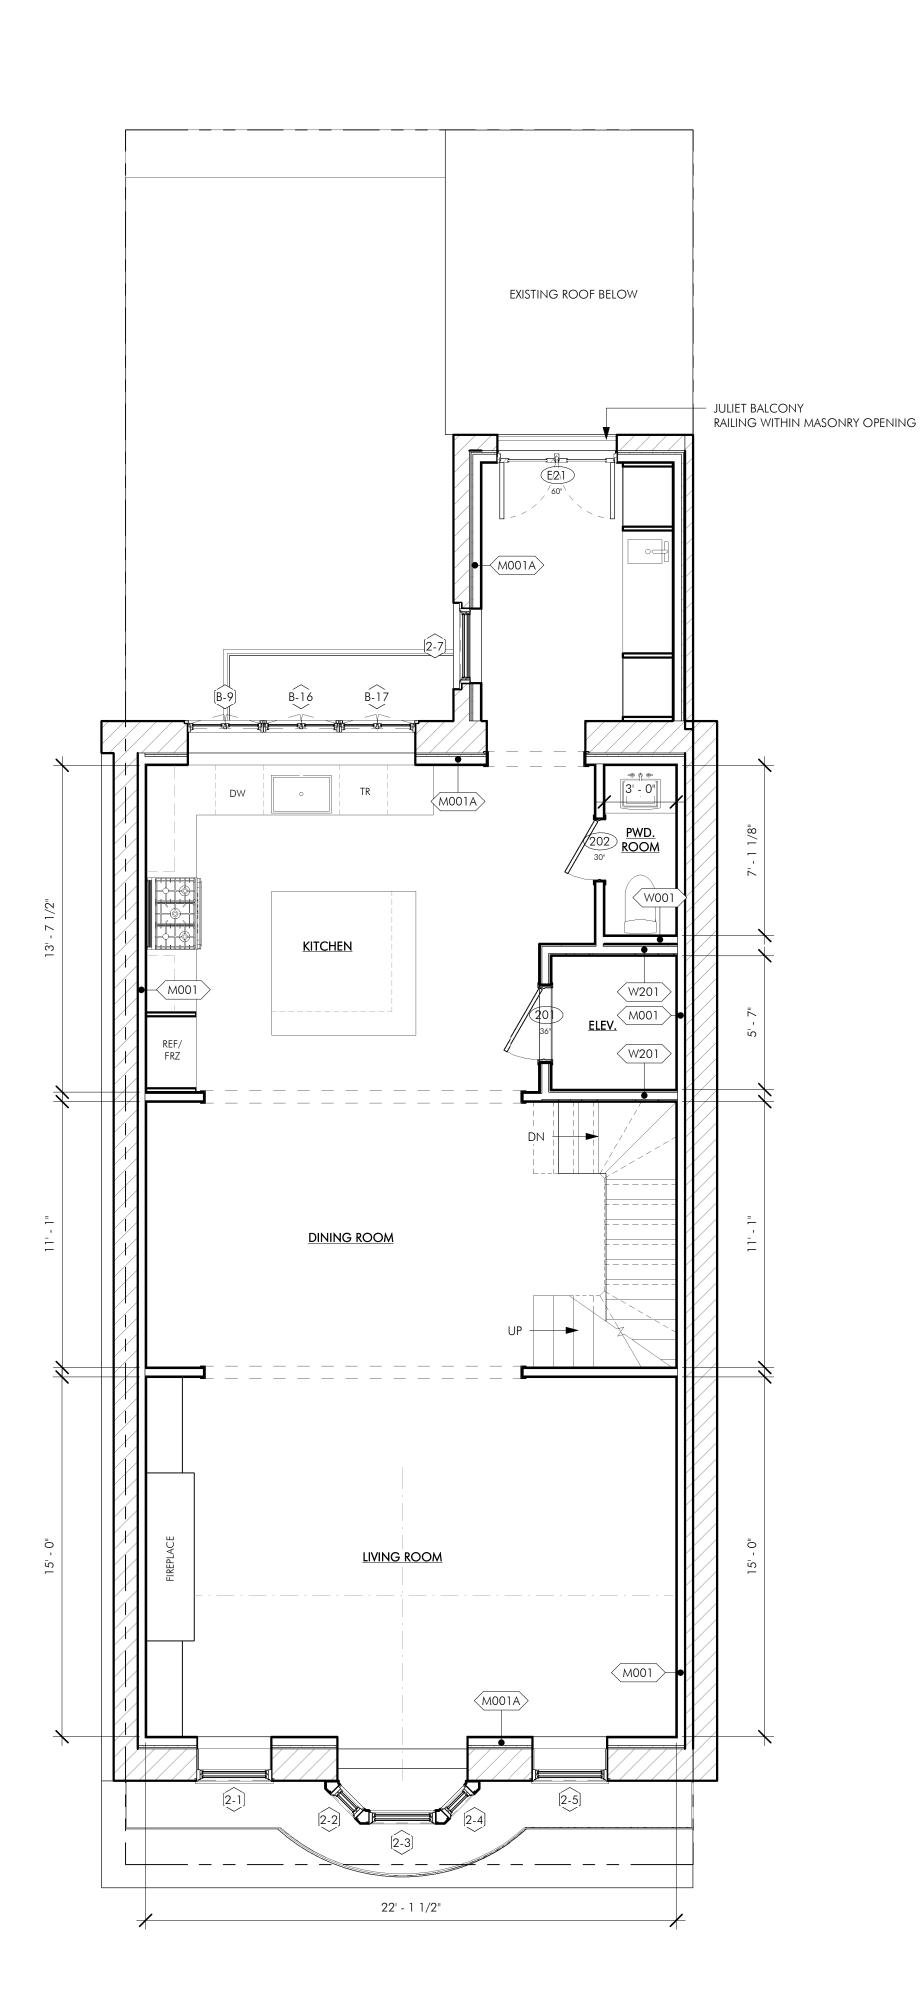

GENERAL NOTES

- 1. WHEN SPECIFIC FEATURES OF CONSTRUCTION ARE NOT FULLY SHOWN ON THE DRAWINGS OR CALLED FOR IN THE GENERAL NOTES, THEIR CONSTRUCTION SHALL BE OF THE SAME CHARACTER AS SIMILAR CONDITIONS.
- 2. ALL DIMENSIONS ARE TO BE TAKEN FROM NUMERIC DESIGNATIONS ONLY; DIMENSIONS ARE NOT TO BE SCALED OFF THE DRAWINGS.
- 3. ALL INTERIOR DIMENSIONS ARE TO FACE OF FINISH UNLESS OTHERWISE NOTED.
- 4. ALL GYPSUM BOARD SURFACES ARE TO BE 5/8" THICK UNLESS OTHERWISE NOTED.
- 5. ALL GYPSUM AND PLASTER FINISHES SHOULD BE SMOOTH, CONTINUOUS, FREE OF IMPERFECTIONS. AND HAVE NO VISIBLE JOINTS.
- 6 PROVIDE GAS, WATER SPIGOT, OUTLET, AND LIGHTING AT ROOF DECKS; FOR LOCATIONS, SEE FLOOR PLANS AND REFLECTED CEILING PLANS.
- 7. ALL CLOSETS SHALL HAVE SHELF AND POLE OR SHELVES AS REQUIRED, UNLESS OTHERWISE NOTED.
- 8. ALL REQUIRED LIFE SAFETY DEVICES, INCLUDING SMOKE & CARBON MONOXIDE DETECTORS, SHALL BE INSTALLED BY THE CONTRACTOR IN COMPLIANCE WITH THE 2015 INTERNATIONAL BUILDING CODE

PLAN NOTES

- 1. ALL DIMENSIONS ARE MEASURED FROM FACE OF EXISTING BRICK TO FINISH FACE OF G.W.B. OR FROM FINISH FACE OF G.W.B. TO FINISH FACE OF G.W.B.
- 2. ALL DOORS ARE 84" TALL UNLESS OTHERWISE NOTED.
- 3. ALL EXISTING PARTY WALLS AND EXTERIOR WALLS TO RECIEVE FURRING WALL TYPE AS Indicated on Plans

MECHANICAL | SECURITY NOTES


- 1. PROVIDE NEST LEARNING THERMOSTAT AT EACH UNIT. (ZONING PER FLOOR LEVEL IN DUPLEX UNITS)
- 2. HEATING AND AIR CONDITIONING IS TO BE PROVIDED BY HIGH VELOCITY FORCED AIR SPACE PAK HIGH VELOCITY AIR CONDITIONING SYSTEMS WITH HYDRONIC HEATING.
- 3. HOT WATER IS TO BE PROVIDED BY A HIGH EFFICIENCY NAVIEN MODULATING CONDENSING COMBINATION HEATING AND HOT WATER SYSTEM OR EQUAL.

ELECTRICAL NOTES

OTHERWISE NOTED:

- 1. ELECTRICAL SERVICE POWER IS TO BE EVALUATED FOR MEETING LIGHTING DESIGN AND EQUIPMENT REQUIREMENTS. PROPER POWER LEVEL SHALL BE PROVIDED.
- 2. ALL NEW ELECTRICAL ITEMS ARE TO BE U.L. RATED.
- 3. ALL ELECTRICAL PANELS ARE TO BE RECESSED INTO A WALL WITH A MINIMUM 6"
- 4. ALL DISTRIBUTION PANELS ARE TO BE NEW.
- 5. LIVING AREAS, DINING AREAS, AND ALL BEDROOM ARE TO RECEIVE 3-WIRE JUNCTION BOXES.
- 6 PROVIDE INTERCOM AND REMOTE ENTRY DOOR ACCESS BY HOUSING DEVICES, INC. OR APPROVED EQUAL.
- 7. PROVIDE ELECTRIC HEAT MATS BY NUHEAT OR EQUAL AT ALL BATHROOMS.
- 8. ALL CLOSET LIGHTING IS TO BE L.E.D. OR HIGH EFFICIENCY LIGHTING.
- 9. OUTLETS IN BATHROOMS SHALL HAVE GROUND FAULT INTERCEPTORS. 10. ALL SMOKE DETECTORS SHALL RECEIVE THEIR PRIMARY SOURCE OF POWER FROM
- BUILDING WIRING WITH BATTERY BACK-UP. 11. ALL DIMENSIONS FOR THE FOLLOWING ITEMS ARE TO FINISH SURFACES UNLESS
- A. MOUNT ALL OUTLETS, PHONE JACKS, AND TELEVISION CABLE JACKS VERTICALLY AT 18" TO CENTERLINE ABOVE THE FINISH FLOOR UNLESS OTHERWISE NOTED. WHERE BASE AND TRIM IS LARGER THAN 9-1/2" TALL PROVIDE 6" CLEARANCE FROM BOTTOM OF PLATE TO TOP OF BASEBOARD
- B. MOUNT ALL SWITCHES AT 42" TO CENTERLINE ABOVE FINISH FLOOR UNLESS C. VERTICALLY ALIGN SWITCHES AND OUTLETS WHERE POSSIBLE.

FLOOR PLAN LEGEND

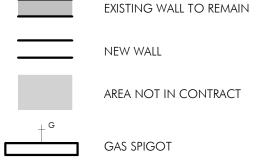

TV LOCATION

THERMOSTAT LOCATION

WATER SPIGOT WATERPROOF OUTLET STRUCTURED VIDEO LOCATION | ARCHITECT

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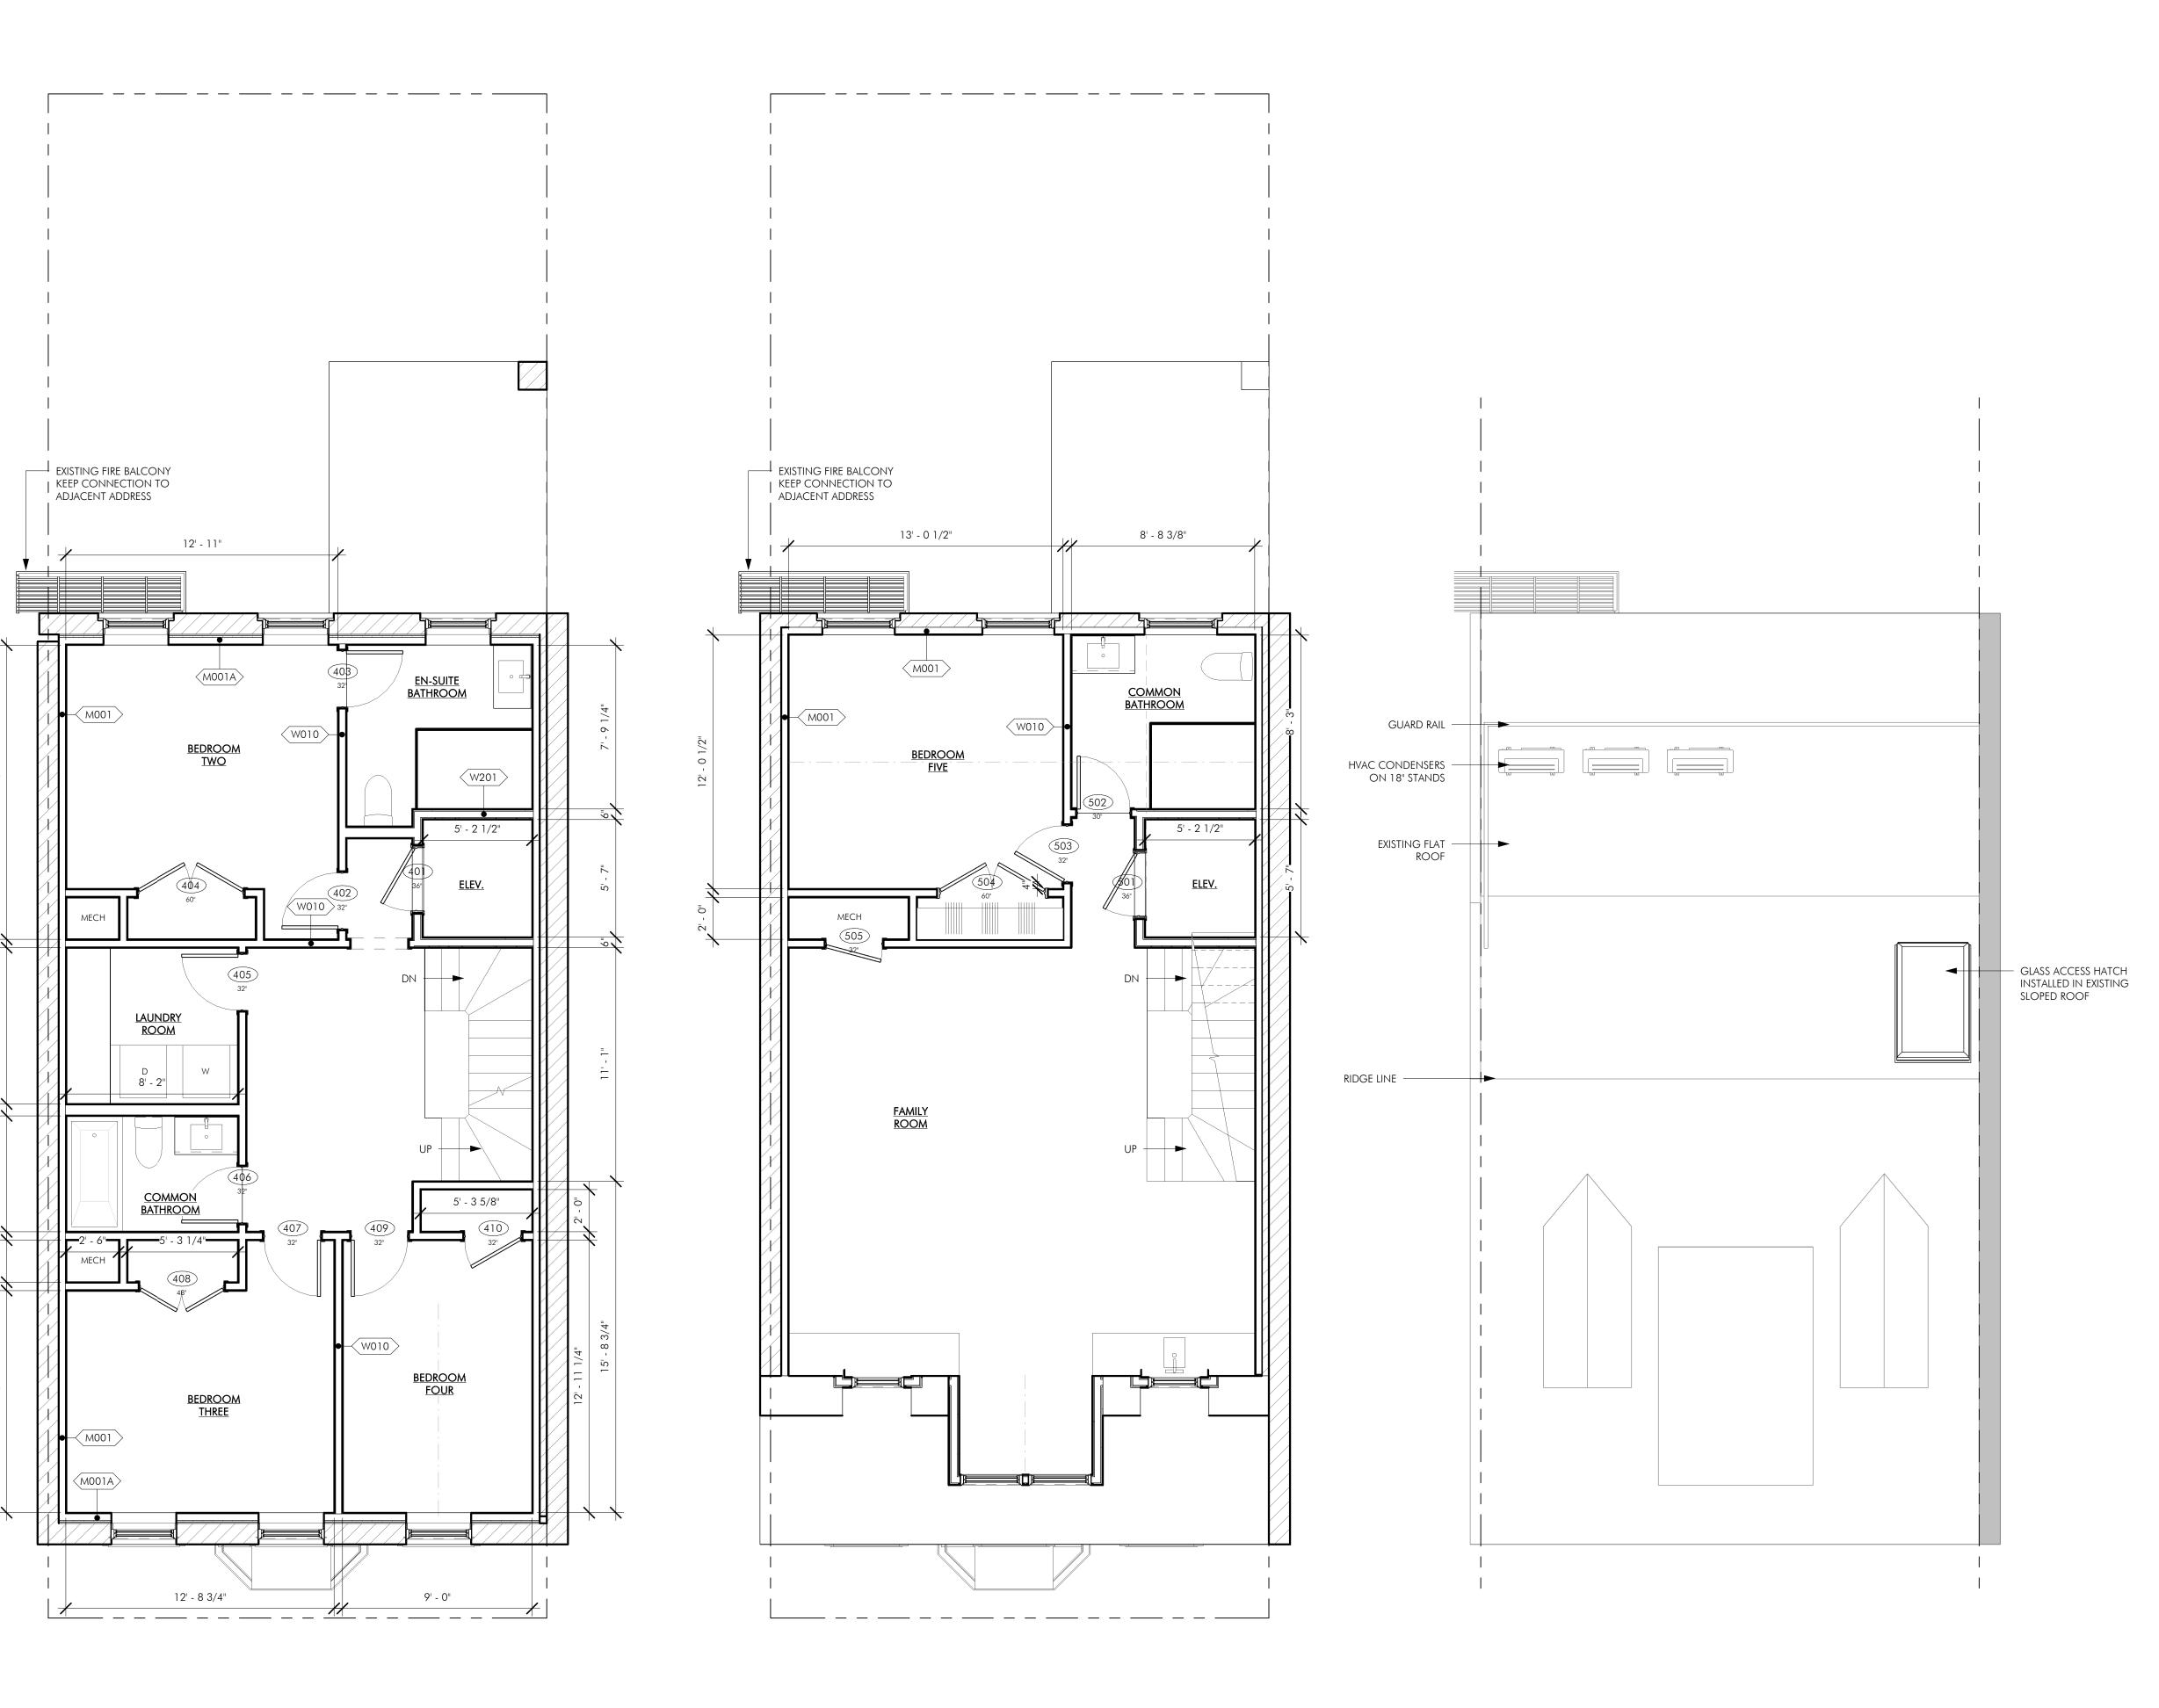
ISSUE: ISSUED FOR CONSTRUCTION AUGUST 30, 2022 PROJECT #: 22010

1/4" = 1'-0"

DRAWING TITLE CONSTRUCTION

DRAWING NUMBER

PLANS



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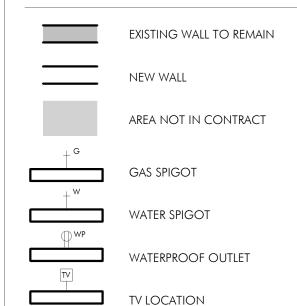
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- 3. ALL ELECTRICAL PANELS ARE TO BE RECESSED INTO A WALL WITH A MINIMUM 6" STUD DIMENSION. REVIEW FINAL LOCATION WITH ARCHITECT AND OWNER.
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 C. VERTICALLY ALIGN SWITCHES AND OUTLETS WHERE POSSIBLE.

FLOOR PLAN LEGEND



STRUCTURED VIDEO LOCATION

THERMOSTAT LOCATION

REVISIONS

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 ISSUE:
 ISSUED FOR CONSTRUCTION

 DATE:
 AUGUST 30, 2022

 PROJECT #:
 22010

 SCALE:
 1/4" = 1'-0"

DRAWING TITLE

CONSTRUCTION

DRAWING NUMBER

PLANS

A103




EMBARC 580 HARRISON AVE, SUITE 2W BOSTON, MA 02118 O: 617.765.8000 www.embarcdesign.com OWNER 7 CHESTNUT STREET LLC 92 HIGH STREET, SUITE 22 MEDFORD, MA 02155 CONSULTANTS ONSTRUCTION ISSUED REVISIONS MARK ISSUE DATE


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AUGUST 30, 2022 PROJECT #: 22010 1/4" = 1'-0"


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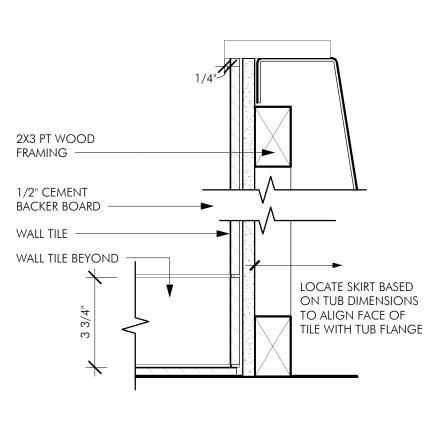





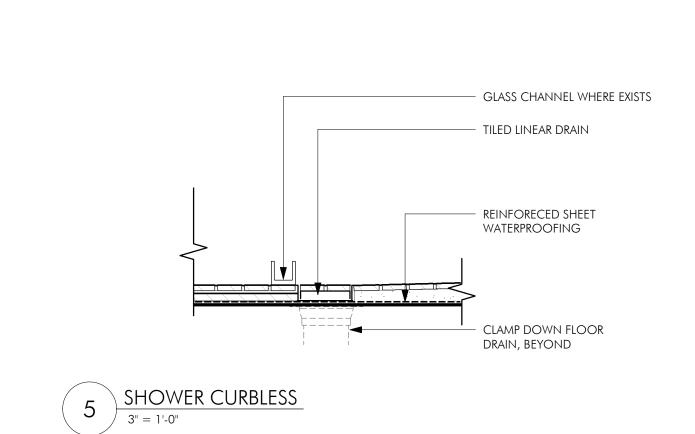


BATHROOM FLOOR ASSEMBLY

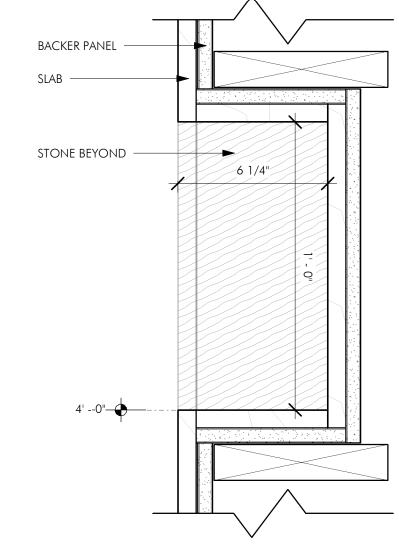


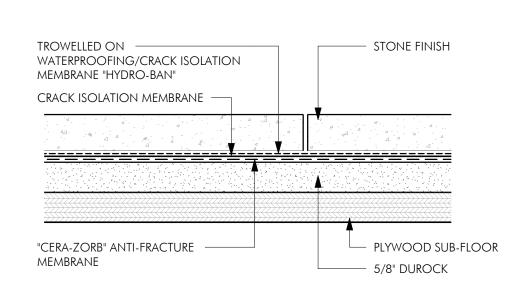

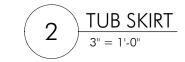

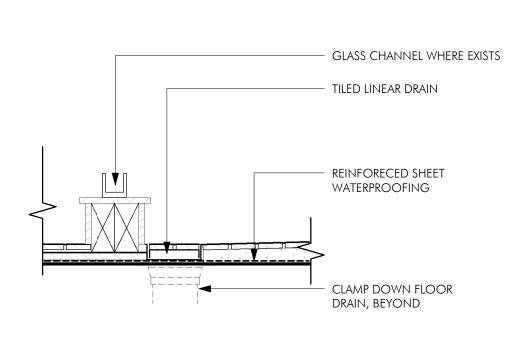



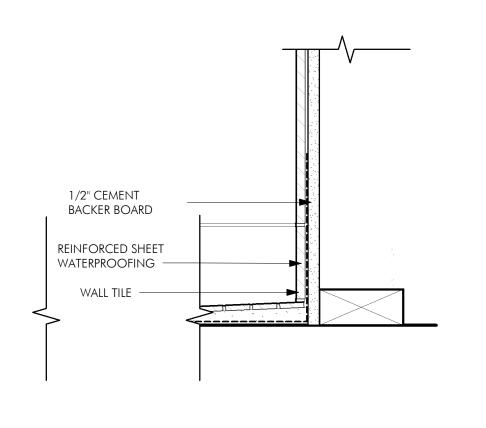





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DATE: AUGUST 30, 2022 PROJECT #: 22010 SCALE: As indicated

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ARCHITECT EMBARC 580 HARRISON AVE, SUITE 2W BOSTON, MA 02118 O: 617.765.8000 www.embarcdesign.com OWNER 7 CHESTNUT STREET LLC 92 HIGH STREET, SUITE 22 MEDFORD, MA 02155 CONSULTANTS CHESTNU STON, MA 02108 ISSUED REVISIONS MARK ISSUE DATE NOTES: 1 1/2" - 6" 1. APPLY IN-SEAM SEALANT 1/2" FROM INSIDE EDGE OF PIPE SEAL FLANGE TO THE DECK FLANGES OF THE PRE-MOLDED PIPE PREMOLDED PIPE SEAL MUST HAVE INTACT RIB AT TOP EDGE, REGARDLESS OF PIPE DIAMETER FLASHING SHALL NOT BE OVERLAPPED, CUT, OR APPLIED OVER ANY ANGLE CHANGE — STAINLESS STL CLAMPING RING — WATER CUT-OFF MASTIC PRE-MOLDED PIPE, SEAL AS SPECIFIED — In-seam sealant. (see note 1) ____ LAP SEALANT - EPDM MEMBRANE ROOFING — ROOF INSULATION DRAWING INFORMATION ISSUE: ISSUED FOR CONSTRUCTION — SEAL ALL PENETRATIONS DATE: AUGUST 30, 2022 PROJECT #: 22010 VAPOR BARRIER SCALE: 3" = 1'-0" SEAL VAPOR BARRIER TO ALL PIPE PENETRATIONS DRAWING TITLE EXTERIOR DETAILS 1 SECTION AT PIPE FLASHING AT MEMBRANE ROOFING DRAWING NUMBER