



71 CHARLES STREET
BOSTON, MA 02114

SHEET TITLE:
PROPOSED
FRONT & REAR
ELEVATIONS

DATE: FEBRUARY 13, 2020
SCALE: AS NOTED
DRAWN: JGUR & RJP
CHECKED: JGUR & MZP



ENLARGED FRONT ELEVATION FULL: 1" = 1'-Ø", HALF: 1/2" = 1'-Ø"




## 71 CHARLES STREET BOSTON, MA Ø2114

PROPOSED ENLARGED FRONT ELEVATION

DATE: FEBRUARY 13, 2020

SHEET NO.

SCALE: AS NOTED DRAWN: JGUR & RJP JGUR & MZP CHECKED:

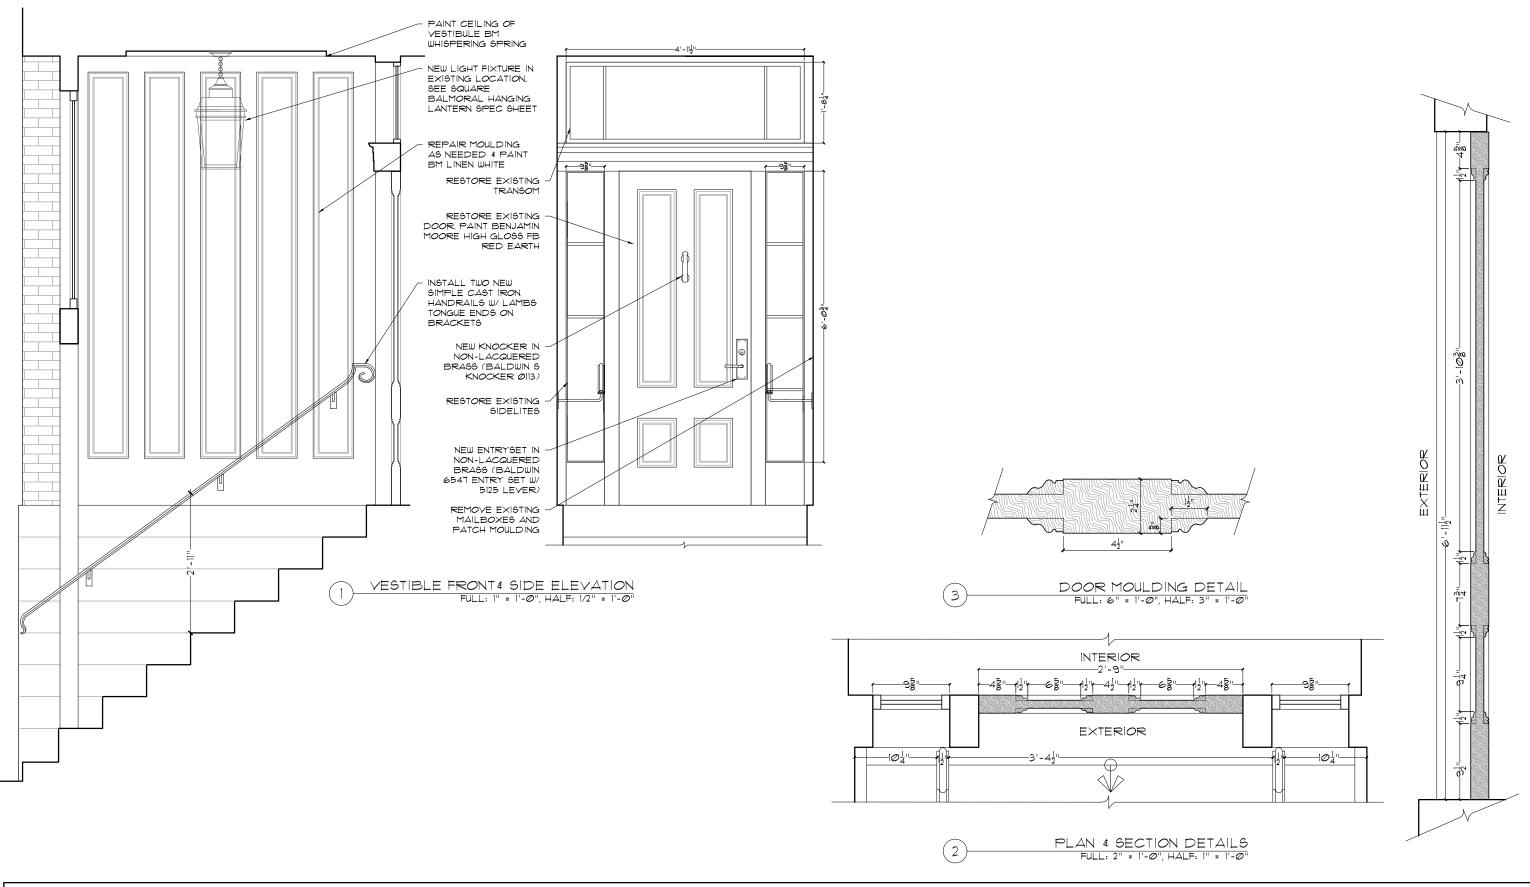



71 CHARLES STREET
BOSTON, MA Ø2114

SHEET TITLE:
PROPOSED
VESTIBULE DETAILS

DATE: FEBRUARY 13, 2020

DATE: FEBRUARY 13, 2020


SCALE: A\$ NOTED

DRAWN: JGUR & RJP

CHECKED: JGUR & MZP

A-3

SHEET NO.

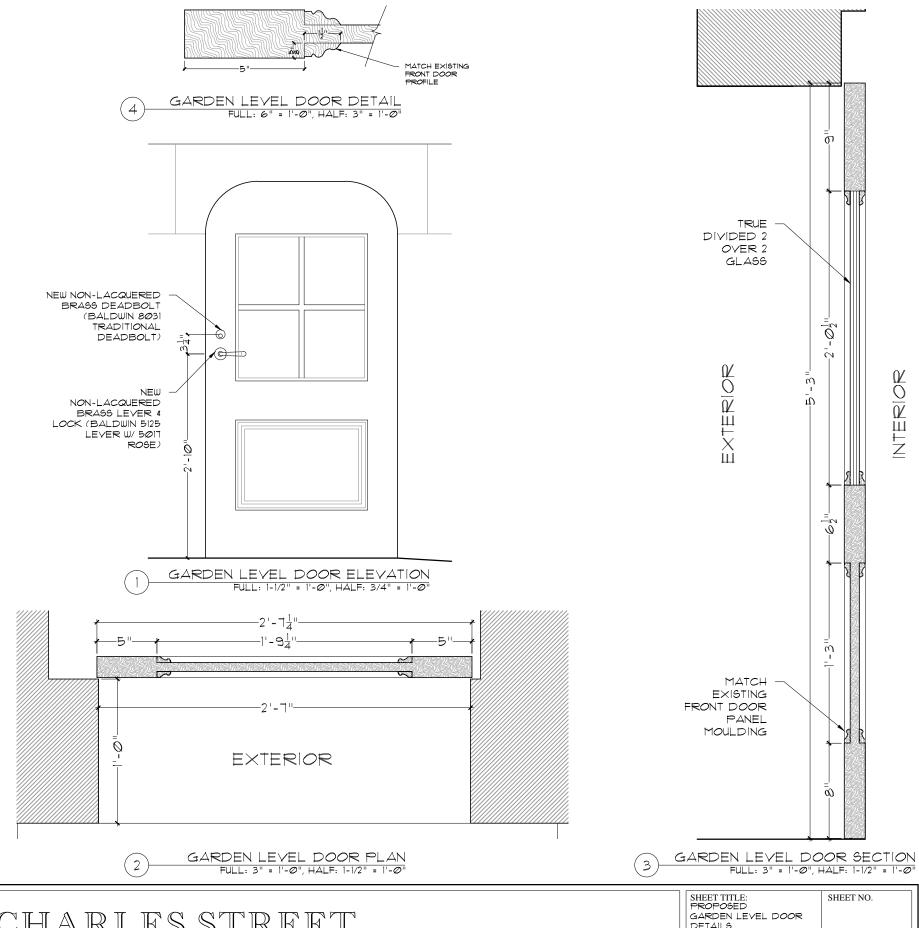



71 CHARLES STREET
BOSTON, MA Ø2114

SHEET TITLE:
PROPOSED
GARDEN LEVEL DOOR
DETAILS

DATE: FEBRUARY 13, 2020
SCALE: AS NOTED
DRAWN: JGUR & RJP
CHECKED: JGUR & MZP


## GARDEN LEVEL DOOR HARDWARE SPECIFICATION

## 5125 **ESTATE LEVER**

SPECIFICATIONS





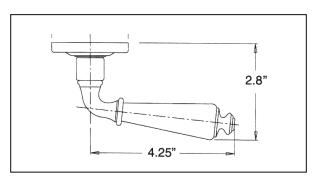

- > Accessibility Code (ADA) A117.1 for all levers.
- > Certified by Underwriters Laboratories (UL) for use on fire doors up to three-hour rating
- > U L10C / UBC 7-2 (1997) Positive Pressure Rated, UL10B Pressure Rated
- > Material: Solid Brass

### SHOWN WITH ROSE 5017






## TIER 2 FINISHES



## **BALDWIN®**


WHERE TO BUY

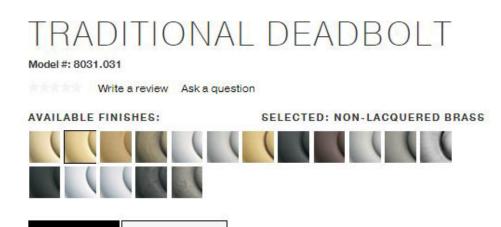



ADD TO WISH LIST

# **GARDEN LEVEL WINDOW SPECIFICATIONS**

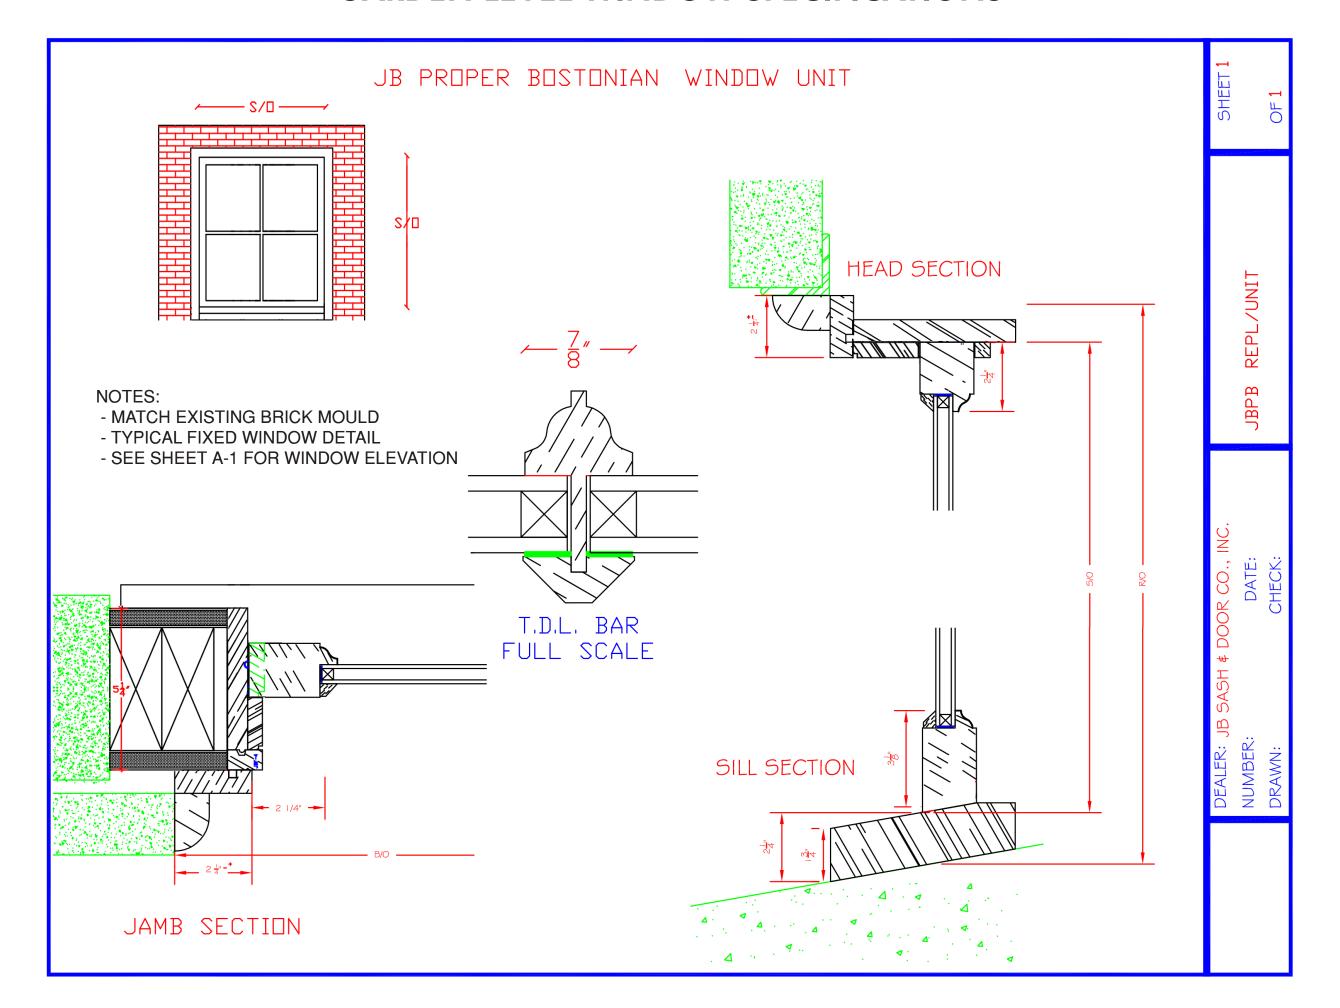

# FRONT DOOR LANTERN SPECIFICATIONS

1/23/2020 John Rosselli Antiques

# JOHN ROSSELLI ANTIQUES

Heritage . Antiques . Reproductions . Fabric . Events . Contact Us



**FLUSH OUTLET** 



Туре	NPT INLET SIZE (Inches)	OUTLETS		BODY TYPE		MEASUREMENTS (Inches)							AVAILABLE ESCUTCHEON LETTERING		FINISH								
		2.5	mber ' M N outlet	THI	Straight	°06	A	В	С	D	E	F	G	н	J	Pump Test	Wall Hydrant	Polished Brass	Polished Chrome	Weight (Lbs.)	MODEL	FIGURE	FM APPROVED
Hydrant	21/2	•					<b>7</b> ½		П	31/4							S	S	0	6¾	152 2.5"	1	П
		•					101/2			31/4				7			S	S	0	9¾	162 2.5"	2	П
	3	•					<b>7</b> ½			37/16							S	S	0	5¾	152 3"	1	
		•					101/2			37/16				7			S	S	0	8¾	162 3"	2	
	4		•		S		13∛₁6	<b>7</b> ½				5	67/16	8916	111/4		S	S	0	31	163 4" ST*	3	•
			•			0	13∛₁₅	<b>7</b> ½	3⅓	31/16	6 <sup>13</sup> / <sub>16</sub>	5	6∜16	5⅓	111/2		S	S	0	28¾	163 4" 90*	4	Ŀ
	6		•		S		13∛₁₅	<b>7</b> ½				71/2	8	89/16	111/2		S	S	0	351/4	163 6" ST*	3	Ŀ
			•			S	12	7⅓8	<b>4∛</b> <sub>32</sub>	37/16	4	7⅓	7¾	615/32			S	S	0	32¾	163 6" 90*	4	Ŀ
Pump Test Connections	4		•		S		13∛₁₅	<b>7</b> ½				5	67/16	8916	111/4	S		S	0	31	163P 4" ST	3	Ŀ
			•		ш	S	13∛₁₅	<b>7</b> ½	3⅓8	31/16	6 <sup>13</sup> / <sub>16</sub>	5	6∜16	5⅓	111/2	S		S	0	28¾	163P 4" 90	4	Ŀ
	6		•		S		13∛₁₅	<b>7</b> ½				<b>7</b> ½	8	89/16	111/2	S		S	0	351/4	163P 6" ST	3	Ŀ
			•			S	13∛₁₅	<b>7</b> %	<b>4</b> <sup>3</sup> / <sub>32</sub>	37/16	4	<b>7</b> ½	7¾	¥ <sub>32</sub>	12	S		S	0	32¾	163P 6" 90	4	Ŀ
				•	S		201/8	6⅓				7⅓8	61/8	91/2	<b>17</b> ∜₁6	S		S	0	68	167-WP	5	Ш
				•		S	201/4	6⅓				71/8	8³/16	91/2	171/4	S		S	0	701/2	167-WP 90	6	Ш

s = standard

### \* Can order body separately.

### **ADDITIONAL INFORMATION**

- Bodies rated for 175 psi (12.1 bar).
- Each 21/2" NHT outlet has a rated flow of 250 gpm (946 lpm).

**BUILDING CONNECTIONS** 

• Supplied with cap(s) (#310) and chain(s).

### **THREADS**

Unless otherwise noted, all hose threads are NHT. See index T-13 for available optional threads.


### **OTHER PRODUCTS**


• See page 13-20 for Flush 4-Way Outlet Connections.

164

- 21/2" NPT nipple required for all 163, 163P and 167 WP models. Elkhart Brass does not supply.
- On the 163 and 163P, the body is roughed in during construction; escutcheon and nipple assemblies are installed after construction. Elkhart Brass personnel can help with construction installation information.

### **OPTIONS**

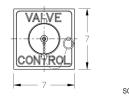

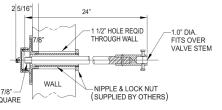

- 164 A cast brass valve control for use with Elkhart's model 163 is available. The 164 comes with a 1/8" square steel extension rod that is 24" long and has a special coupling for attaching to stem of gate valve. Additionally, a cap, chain and 7" square escutcheon are included. Please specify polished brass or polished chrome-plated. (Note: a 21/2" hole is required in the installation wall)
- 480 Tee handle used with 164 control valve.

## Pulse Alert TECHNOLOGY

# Sonos Pulse Wall - Red Flash

## Sonos Pulse Wall - Red Flash

Sonos Pulse wall mounted Visual Alarm Devices are available as fire beacons or combined sounder beacons. With an EN54-23 approved coverage pattern of W-2.4-7.5, each Sonos Pulse wall mounted device can be mounted up to 2.4m high and can cover an 7.5m x 7.5m square room with a single device.



Specifications	Beacons	Sounder Beacons				
Voltage	17-60V DC	17-60V DC				
Current @ 0.5Hz	20mA	25.1mA				
Current @ 1Hz	40mA	45.1mA				
Flash Colour	Red	Red				
Body Colour	Red or White	Red or White				
Ingress Protection	IP65 (Deep base)	IP65 (Deep base)				
Operating Temp.	-25°C to +70°C	-10°C to +55°C				
Sound Output	N/A	97dB(A)				





Feature	Benefit						
Conforms to EN54-23	Exceeds the illumination requirements of EN54-23						
Pulse Alert™ Technology	Patented electronic design maximises system efficiency by minimising power consumption						
7.5m Coverage volume	Reduces the number of devices required; most rooms can be protected with a single device						
Wire to Base Technology	Installation is quick and simple with mounting and wiring made only to the base, the head clicks on to the base during commissioning						
Simple Upgrade	Sonos Pulse VADs share the same base mounting and wiring as previous versions, making the transition to 'Pulse' versions as simple as possible						
Optimum Performance Level	Pulse Alert™ Technology enables the coverage pattern to be fixed at the optimum performance level						
Synchronised Flash	Sonos Pulse VADs protect everyone including people prone to photosensitive epilepsy						
No Surge Current	Eliminates power surges during system start up						
Weatherproof to IP65	Surpasses the Ingress Protection requirements of EN54-23 making them suitable for a wide variety of environmental conditions						